

ACTIVITY DETERMINATION

Project No. BGYPW

Conflict of Interest¹

In this matter:

- 1. I have declared any possible conflict of interests (real, potential or perceived) to the Acting Chief Executive Officer, Land & Housing Corporation.
- 2. I do not consider I have any personal interests that would affect my professional judgement.
- 3. I will inform the Acting Chief Executive Officer, Land & Housing Corporation as soon as I become aware of a possible conflict of interest.

Signed..... Emma Nicholson Acting Head of Policy and Innovation Land and Housing Corporation... 20 December 2023

Having regard to the Determination Recommendation Report, the Statement of Compliance and the Review of Environmental Factors for this project addressing matters under Part 5 of the *Environmental Planning and Assessment Act 1979,* I determine that the activity proceed as described below and subject to the identified requirements set out in **Schedule 1**.

SITE IDENTIFICATION		
STREET ADDRESS		
Unit/Street No	Street or property name	
52-56	Pank Parade	
Suburb, town or locality		Postcode
Blacktown, NSW		2148
Local Government Area(s)	Real property description (Le	ot and DP)
Blacktown	Lots 41, 42 & 43 DP 32163	
ACTIVITY DESCRIPTION		

Provide a description of the activity

Demolition of 3 existing dwellings and structures, and the construction of 12 independent living seniors housing units comprising 6 x 1 bedroom and 6 x 2 bedroom units, with associated landscaping and fencing, surface parking for 6 cars, and consolidation into a single lot.

^{1.} Conflict of interest includes actual and potential. A conflict of interest includes pecuniary i.e. financial interests to you or a related party or non-pecuniary i.e. benefits to relatives, friends, business associates and personal causes, etc. This includes "related persons" as defined in the Property, Stock and Business Agency Act 2002.

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Signed.....

Dated.....20 December 2023

Emma Nicholson Acting Head of Policy and Innovation Land and Housing Corporation

SCHEDULE 1

Recommended Identified Requirements

PART A – Standard Identified Requirements

THE DEVELOPMENT

The following identified requirements are to ensure that the **seniors housing** activity is carried out in accordance with the plans / documents and any amendments arising from the Review of Environmental Factors under Part 5 of the Environmental Planning & Assessment Act 1979, Section 171 of the Environmental Planning and Assessment Regulation 2021 and the requirements of State Environmental Planning Policy (Housing) 2021

1. The development shall be carried out substantially in accordance with the following plans / documents and as modified below by any of the undermentioned identified requirements:

Title / Name:	Drawing No. /	Revision /	Date	Prepared by:
	Document Ref	Issue:	[dd.mm.yyyy]:	
Architectural				
Cover Sheet	AR-0000	Р	16.11.2023	MODE Design
Legends/Notes	AR-0001	М	16.11.2023	MODE Design
3D View & Development	AR-0002	R	16.11.2023	MODE Design
Data Table				
3D Views	AR-0003	L	16.11.2023	MODE Design
Site Analysis	AR-0004	Н	16.11.2023	MODE Design
Block Analysis Plan	AR-0005	Н	16.11.2023	MODE Design
Site Plan	AR-0100	0	16.11.2023	MODE Design
Demolition Plan	AR-0500	L	16.11.2023	MODE Design
General Arrangement	AR-1000	S	16.11.2023	MODE Design
Plan – Ground Level				
General Arrangement	AR-1001	Q	16.11.2023	MODE Design
Plan –First Level				
General Arrangement	AR-1002	N	16.11.2023	MODE Design
Plan – Roof				
Elevations	AR-2000	N	16.11.2023	MODE Design
Sections	AR-2100	М	16.11.2023	MODE Design
Door & Window	AR-4100	М	16.11.2023	MODE Design
Schedules				
Photomontage – Sheet 1	AR-8000	G	16.11.2023	MODE Design
Photomontage – Sheet 2	AR-8001	G	16.11.2023	MODE Design
Solar Analysis	AR-8100	N	16.11.2023	MODE Design

Solar Study Sheet 2 AR-8201 I 16.11.2023 MODE Design Landscape Cover Sheet LD-0000 C 0.911.2023 MODE Design Landscape Plan LD-1000 I 22.11.2023 MODE Design Landscape Details 1 LD-5001 B 0.911.2023 MODE Design Landscape Details 2 LD-5002 B 0.911.2023 MODE Design Landscape Details 3 LD-5003 A 0.911.2023 MODE Design Landscape Details 3 LD-5003 A 0.911.2023 MODE Design Control Plan C11.1 P3 11.112022 Engineering Studio Control Plan C12.01 P3 11.112022 Engineering Studio Stormwater Details Sheet C12.02 P3 11.112022 Engineering Studio Structural First Floor Plan SK02 3 18.112022 MODE Design Roof - Plan SK03 3 18.112022 MODE Design Structural Stortinde Level Survey 3404/22 <t< th=""><th>Solar Study – Sheet 1</th><th>AR-8200</th><th></th><th>16.11.2023</th><th>MODE Design</th></t<>	Solar Study – Sheet 1	AR-8200		16.11.2023	MODE Design
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- 2. All building work is to be undertaken in accordance with the National Construction Code and referenced Australian Standards.
- 3. All commitments listed in the BASIX certificate and stamped plans shall be implemented.

- 4. All construction documentation and building work are to be certified in accordance with Section 6.28 of the *Environmental Planning and Assessment Act* 1979.
- 5. The land the subject of this determination shall be consolidated into a single lot. The plan of consolidation shall be lodged at the NSW Land Registry Services and shall be registered prior to the occupation of the development. A copy of the registered plan shall be provided to the Land & Housing Corporation.

OPERATIONAL MATTERS

The following Identified Requirements relate to the use of the site and are to ensure that the activity and its operation do not interfere with the amenity of the surrounding area.

Stormwater Run-off

- 6. Stormwater shall be collected within the site and conveyed in a pipeline to the appropriate gutter or drain under the control of the Blacktown City Council substantially in accordance with the approved concept stormwater drainage plans.
- 7. Alterations to the natural surface contours or surface absorption characteristics of the site shall not impede, increase or divert natural surface water runoff so as to cause a nuisance to adjoining property owners.
- 8. All driveways shall be graded in such a manner as to provide continuous surface drainage flow paths to the appropriate points of discharge.
- 9. To prevent water from entering buildings, surface waters shall be collected and diverted clear of the buildings by a sub-surface / surface drainage system.

Vehicular Access & Parking

- 10. A concrete vehicular crossing and layback shall be provided at the entrance / exit to the property. The crossing and layback shall be constructed in accordance with Blacktown City Council's standard requirements for residential crossings. Council shall be provided with plans for the crossing and layback together with the payment of any council inspection fees.
- 11. Particular care shall be taken in the location of vehicular crossings and/or laybacks to avoid poles, pits etc. The cost of any necessary adjustments to utility mains and services associated with the construction of the layback/driveway shall be borne by the Land & Housing Corporation. Obsolete gutter laybacks shall be constructed as kerb in accordance with the Blacktown City Council's standards.

Note: It is recommended that discussions be held with the relevant authorities before construction works commence.

12. Car parking spaces and the driveway shall be constructed of concrete or other approved hard surface materials. The car parking spaces must be clear of obstructions and columns, permanently line marked and provided with adequate manoeuvring facilities. The design of these spaces must comply with AS 2890.1.

Site Works

13. All soil erosion and sediment control measures required to be put in place prior to the commencement of demolition / construction works shall be maintained during the entire period of the works and until all the disturbed areas are restored by turfing, paving or revegetation. Soil erosion and sediment control measures shall be designed in accordance with the guidelines set out in the Blue Book *Managing Urban Stormwater: Soils and Construction* (4th edition, Landcom, 2004).

14. An appropriately qualified person shall design any retaining walls or other methods necessary to prevent the movement of excavated or filled ground, including associated stormwater drainage measures.

Building Siting

15. All buildings shall be sited well clear of any easements affecting the site. The builder shall ascertain if any easements do exist and, and if they do, obtain full details of such prior to construction commencing.

Smoke Detection System(s)

- 16. Smoke detection systems shall be installed throughout the building(s) in accordance with requirements of Clause E2.2a of the Building Code of Australia. Detectors and alarms shall comply with AS 3786 and AS 1670 and must be:
 - i. connected to a permanent 240V power supply; and
 - ii. provided with a battery backup to activate the alarm unit in the event of failure of the permanent power supply.

Site Soil Contamination

17. If the site is identified as being potentially affected by soil contamination, it shall be inspected by a suitably qualified person to identify any contaminated or hazardous material present. A proposal for remediation shall be prepared, which may include preparation of a Remedial Action Plan, and remediation shall be carried out in accordance with the proposal. A Validation Report, prepared in accordance with Environment Protection Authority requirements, shall be obtained from a qualified expert on completion of the remediation work to verify that the site is suitable for the intended residential use. A copy of the Validation Report shall be provided to the Land & Housing Corporation on completion of the remediation works.

Landscaping

- 18. Landscaping shall be carried out substantially in accordance with the approved Landscape Plan(s) and maintained for a period of 12 months by the building contractor. The Council for the area shall be consulted in relation to the planting of any street trees.
- 19. All scheduled plant stock shall be pre-ordered prior to commencement of construction or 3 months prior to the commencement of landscape construction works, whichever occurs sooner, for the supply to the site on time for installation. The builder shall provide written confirmation of the order to the Land & Housing Corporation.

Fencing

20. All front fencing and gates shall be constructed wholly within the boundaries of the site. Any gates associated with the fencing shall swing inwards towards the site.

Provision of Letterbox Facilities

21. Suitable letterbox facilities shall be provided in accordance with Australia Post specifications.

Public Liability Insurance

22. A valid public liability insurance policy of at least \$10M shall be maintained throughout the demolition / construction works by the building contractor.

PRIOR TO ANY WORK COMMENCING ON THE SITE

The following Identified Requirements are to be complied with prior to any work commencing on the site, including demolition.

Disconnection of Services

- 23. All services that are required to be disconnected shall be appropriately disconnected and made safe prior to commencement of the demolition / construction works. The various service authorities shall be consulted regarding their requirements for the disconnection of services.
- 24. All existing services within the boundary to remain live shall be identified, pegged and made safe.

Demolition

- 25. The builder shall notify the occupants of premises on either side, opposite and at the rear of the site a minimum of two days prior to demolition. Such notification shall be clearly written on an A4 size paper giving the date demolition will commence and be placed in the letterbox of every premise (including every unit in a multi-unit residential building or mixed use building). The demolition shall not commence prior to the date that is stated in the notice letter.
- 26. Prior to the demolition, a Work Plan shall be prepared by a competent person(s) in accordance with AS 2601 and shall be submitted to the Land & Housing Corporation. The Work Plan shall outline the identification of any hazardous materials (including surfaces coated with lead paint), method of demolition, the precautions to be employed to minimise any dust nuisance and the disposal methods for hazardous materials.
- 27. If buildings to be demolished are determined as, or suspected of, containing asbestos cement, a standard commercially manufactured sign containing the words 'DANGER ASBESTOS REMOVAL IN PROGRESS', and measuring not less than 400mm x 300mm, shall be erected in a prominent visible position on the site for the duration of the demolition works.

Note: Any buildings constructed before 1987 is assumed to contain asbestos.

Utilities Service Provider Notification

28. The demolition / construction plans shall be submitted to the appropriate water utility's office (e.g. Sydney Water office) to determine whether or not the development will affect the utility's sewer and water mains, stormwater drains and any easements.

Note:

If the development complies with water utility's requirements, the plans will be stamped indicating that no further requirements are necessary.

Council Notification

29. Blacktown City Council shall be advised by the building contractor in writing, of the date it is intended to commence work, including demolition. A minimum period of 5 working days notification shall be given.

Site Safety

- 30. A sign shall be erected in a prominent position on the site:
 - (a) showing the name, address and telephone number of the responsible Land & Housing Corporation officer for the work, and
 - (b) showing the name of the principal contractor (if any) and the telephone number on which that person may be contacted during and outside working hours, and
 - (c) stating that unauthorised entry to the site is prohibited.

The sign shall be maintained while the work is being carried out but shall be removed when the work has been completed.

Note:

This requirement does not apply in relation to building work that is carried out inside an existing building that does not affect the external walls of the building.

31. A minimum 1.8m high security fence or Class A / Class B (overhead) hoarding must be erected between the work site and any public place prior to demolition / construction. Access to the site shall be restricted to authorised persons only and the site shall be secured against unauthorised entry when demolition / construction work is not in progress or the site is otherwise unoccupied.

Note:

Approval from the relevant roads authority may be required under Section 138 of the Roads Act 1993 where a Class A or B hoarding encroaches onto the footpath of / or a public thoroughfare within a classified road.

32. Building and demolition materials shall not be stored on the footpath or roadway.

Site Facilities

- 33. The following facilities shall be installed on the site:
 - (a) Toilet facilities shall be provided at the rate of 1 toilet for every 20 persons, or part thereof, employed at the site. Each toilet shall be a standard flushing toilet and shall be connected to a public sewer. If connection to a public sewer is not practicable, to an accredited sewerage management facility provided by the Blacktown City Council or if this is also not practicable to some other council approved management facility.
 - (b) Adequate refuse disposal methods and builders storage facilities. Builders' wastes, materials or sheds shall not be placed on any property other than that to which this activity relates.
- 34. Access to the site shall only be provided via an all weather driveway on the property and shall not be provided from any other site.

Protection of Trees

35. Trees and other vegetation that are to be retained on site, adjoining lands, and road reserve shall be protected prior to the commencement of works and for the duration of the construction period in accordance with the details provided in the Arboricultural Impact Assessment and Tree Management Plan.

Waste Management

36. A final Waste Management Plan shall be prepared and submitted to the Land & Housing Corporation by the building contractor prior to the commencement of demolition / construction. The plan shall detail the amount of waste material and the destination of all materials, recyclable and non-recyclable.

PRIOR TO ANY CONSTRUCTION WORK COMMENCING ON SITE

The following Identified Requirements are to be complied with prior to any construction works occurring on the site, excluding demolition.

Service Authority Clearances

37. A compliance certificate, or other evidence, shall be obtained from the relevant water utility provider (e.g. Sydney Water), confirming service availability prior to work commencing.

Note:

Payment of water and/or sewer service charges and/or a notice of requirements for works to be carried out during construction / prior to occupation may be applicable prior to issue of the compliance certificate.

- 38. A written clearance from an electricity supply authority stating that electrical services are available to the site, or that arrangements have been entered into for the provision of services to the site, shall be obtained prior to work commencing.
- 39. A certificate from an approved telecommunications carrier certifying that satisfactory arrangements have been made for the provision of underground telephone services, to the site and to each dwelling, shall be obtained prior to work commencing.
- 40. Where the site is to be connected to reticulated gas, a certificate from an approved gas carrier certifying that satisfactory arrangements have been made for the provision of underground gas services, to the site and to each dwelling, shall be obtained prior to work commencing.

Stormwater Disposal

41. A detailed stormwater drainage plan(s), substantially in accordance with the approved concept stormwater drainage plan(s), shall be prepared and submitted to the Land & Housing Corporation. Any on-site detention system shall be designed in accordance with the relevant catchment authority's requirements (e.g. the Upper Parramatta River Catchment Trust On-site Detention Handbook) and Blacktown City Councils drainage code.

DURING DEMOLITION AND CONSTRUCTION WORKS

The following Identified Requirements are to be complied with whilst demolition and construction works are occurring on the site.

Landfill

- 42. Where site filling is required, a minimum of 95% standard compacting shall be achieved and certified by a NATA registered Soils Laboratory.
- 43. Land fill materials must satisfy the following requirements:
 - i. Shall be Virgin Excavated Natural Matter (VENM);
 - ii. Shall be free of slag and hazardous, contaminated, putrescible, toxic or radio-active matter; and
 - iii. Shall be free of industrial waste and building debris.

Heritage

44. Historic and indigenous archaeological sites and relics are protected under the *Heritage Act* 1977 and *National Parks and Wildlife Act* 1974, respectively. Should any relics be uncovered during the course of the approved works, work must cease immediately in the affected area and the Department of Planning and Environment must be contacted.

45. All workers / contractors on the site shall be informed of their obligations, under the Heritage Act and *National Parks and Wildlife Act 1974,* that it is illegal to disturb, damage or destroy a relic without the prior approval.

Demolition

- 46. Any existing structures identified for demolition shall be demolished prior to commencement of the construction of the activity.
- 47. Demolition shall be carried out in accordance with the appropriate provisions of AS 2601.
- 48. Where materials containing asbestos are to be removed, demolition shall be carried out by a licensed contractor(s) that has a current SafeWork NSW accreditation in asbestos removal.
- 49. Removal of asbestos-based thermal, or acoustic insulation such as sprayed asbestos and asbestos-based lagging and including friable asbestos boards, shall be carried out in accordance with the National Occupational Health and Safety Commission's Code of Practice for the Safe Removal of Asbestos, 2nd Edition [NOHSC:2002 (2005)].
- 50. Hazardous and intractable waste, including all asbestos laden waste arising from the demolition process shall be removed and disposed of in accordance with the requirements of SafeWork NSW.
- 51. Documentary evidence, in the form of tip receipts from an approved Waste Management Facility, shall be obtained by the demolition contractor and submitted to the Land & Housing Corporation demonstrating the appropriate disposal of the asbestos waste.
- 52. Demolition procedures shall maximise the reuse and recycling of demolished materials in order to reduce the environmental impacts of waste disposal.
- 53. During demolition, the public footpath and the public road shall not be obstructed by any vehicles. The public road and footpath shall be swept (not hosed) clean of any material, including clay, soil and sand.
- 54. All vehicles leaving the site with demolition materials shall have their loads covered and vehicles shall not track soil and other material onto the public roads and footpaths. The footpath shall be suitably protected against damage when plant and vehicles access the site. All loading of vehicles with demolished materials shall occur on site.

Survey Reports

55. Survey reports shall be submitted by the building contractor to the Land & Housing Corporation prior to the placement of the footings / slab and on completion of the dwellings to verify the correct position of the structures in relation to the allotment boundaries.

Hours of Demolition / Construction / Civil Work

56. Demolition / construction / Demolition / construction / civil work shall only occur on the site between the hours of 7.00am to 5.00pm Monday to Saturday with no work permitted on Sundays or public holidays.

Excavation & Backfilling

57. All excavations and backfilling associated with the demolition or erection of building(s) shall be executed safely and in accordance with appropriate professional standards. All such work shall be guarded and protected to prevent it from being dangerous to life or property.

Pollution Control

- 58. Any noise generated during the carrying out of the activity shall not exceed the limits specified in the July 2009 Interim Construction Noise Guidelines published by the former Department of Environment and Climate Change.
- 59. No fires shall be lit, or waste materials burnt, on the site.
- 60. No washing of concrete forms or trucks shall occur on the site.
- 61. Any contamination / spills on the site during construction works shall be actively managed and reported immediately to the appropriate regulatory authorities to minimise any potential damage to the environment.
- 62. Dust generation during demolition/ construction shall be controlled using regular control measures such as on site watering or damp cloth fences.
- 63. All vehicles transporting loose materials and travelling on public roads shall be secured (ie closed tail gate and covered) to minimise dust generation.
- 64. Non-recyclable waste and containers shall be regularly collected and disposed of at a licensed landfill or other disposal site in accordance with details set out in the final Waste Management Plan.

Impact of Construction Works

- 65. The Land & Housing Corporation shall bear the cost of any necessary adjustments to utility mains and services.
- 66. Care shall be taken to prevent any damage to adjoining properties. The building contractor shall be liable to pay compensation to any adjoining owner if, due to demolition/construction works, damage is caused to such adjoining property.

Termite Protection

67. To protect buildings from subterranean termite, termite barriers installed in accordance with AS 3660.1, shall be placed on the underside and in penetrations of the concrete slab floor.

In addition, a durable notice must be permanently fixed inside the meter box indicating:

- (a) the method of protection;
- (b) the date of installation of the system;
- (c) where a chemical barrier is used, its life expectancy as listed on the National Registration Authority label; and
- (d) the need to maintain and inspect the system on a regular basis.

PRIOR TO OCCUPATION OF THE DEVELOPMENT

The following Identified Requirements are to be complied with prior to the occupation of the development.

General

68. The occupation of the development shall not commence until all the identified requirements of this determination have been complied with.

Council Infrastructure Damage

69. The cost of repairing any damage caused to the Blacktown City Council assets in the vicinity of the site as a result of demolition / construction works shall be met in full by the building contractor.

Stormwater Drainage

- 70. Prior to occupation, a Work As Executed Plan shall be prepared by the building contractor clearly showing all aspects of the constructed stormwater drainage system, including any onsite detention system. The plan shall demonstrate general compliance with the approved concept stormwater drainage plan(s) and shall include:
 - sufficient levels and dimensions to verify the constructed storage volumes; and
 - location and surface levels of all pits; and
 - invert levels of the internal drainage lines, orifice plates fitted and levels within the outlet control pits; and
 - finished floor levels of all structures; and
 - verification that any required trash screens have been installed; and
 - locations and levels of any overland flow paths; and
 - verification that any drainage lines are located wholly within easements, where applicable.

The Work-As-Executed Plan information shall be shown on the final civil works drawings.

A positive covenant and restriction-as-to-user shall be placed over the onsite detention system in accordance with Blacktown City Council's on-site detention policy to ensure that the system will be adequately maintained. The positive covenant and restriction-as-to-user shall be registered at NSW Land Registry Services prior to occupation. A copy of the registered restriction-as-to-user shall be provided to the Land & Housing Corporation and Blacktown City Council.

PART B – Additional Identified Requirements

Specific Requirements for Seniors Housing

71. The independent living units shall comply with the accessibility and useability standards referenced in section 85 and set out in Schedule 4 of State Environmental Planning Policy (Housing) 2021.

Note:

This requirement does not apply to the provisions set out under sections 2, 7-13 and 15-20 of Schedule 4 for an independent living unit, or part of such a unit, that is located above the ground floor.

- 72. Only the following kinds of people shall be accommodated in the approved development:
 - (a) seniors or people who have a disability; or
 - (b) people who live within the same household with seniors or people who have a disability; or
 - (c) staff employed to assist in the administration and provision of services to the seniors housing development.

Note:

It should be noted that 'seniors', as defined in the Housing SEPP, are any of the following:

- (a) people aged 60 or more years,
- (b) people who are resident at a facility at which residential care (within the meaning of the Aged Care Act 1997 of the Commonwealth) is provided, and
- (c) people who have been assessed as being eligible to occupy housing for aged persons provided by a social housing provider.

A restriction as to user shall be registered against the title of the property, prior to occupation, in accordance with Section 88E of the Conveyancing Act 1919 limiting the use of any accommodation to the kinds of people referred to above and that the dwellings cannot be subdivided.

- 73. Pathway lighting shall be designed to provide a minimum of 20 lux at ground level and be located to avoid glare for pedestrians and adjacent dwellings.
- 74. Access to, and within, the site shall be provided in accordance with AS 1428.1 so that a person using a wheelchair can use common areas and common facilities associated with the activity.
- 75. A 1.2m wide concrete footpath across the site frontage, connecting to the existing footpath system in Pank Parade, shall be constructed in accordance with the Blacktown City Council specifications to provide an accessible pathway from the site to the nearest bus stops.

Note:

The responsible officer at the Blacktown City Council shall be contacted regarding council's specifications and any necessary approvals.

76. Entry doors to units shall be provided with door viewers to enable residents to view approaches to their units without the need to open the door.

Site Specific Requirements

- 77. Contact must be made with Council's Open Space Policy & Tree Management Coordinator should street tree removal be required or should the development be located within the drip-line of any street trees.
- 78. Owner's consent must be obtained for removal of a dead tree within 45 McCulloch Street, Blacktown before commencing any works on the site.

Requirements Resulting from Council Comments

- 79. The bin areas to be designed to meet the requirements of 1x240L waste bin and 1x240L recycling bin per two units and as shown in the site plan.
- 80. The roofed bulky waste storage is to be provided as shown on the site plan and the collection to be managed by LAHC contractors.
- 81. The following monetary contributions under Section 7.11 of the Environmental Planning & Assessment Act 1979 must be paid prior to commencement of construction on the site.

The current indexed contributions are:

S7.11 Contribution	Amount
Stormwater Quality	\$17,435.00.

ADVISORY NOTES

i. Approval of this development activity does not imply or infer compliance with Section 23 of the Disability Discrimination Act 1992. Refer to AS 1428.1 and the Building Code of Australia for detailed guidance.

ii. Information regarding the location of underground services may be obtained from Dial Before You Dig at www.1100.com.au or by dialing 1100.



Decision Statement

Project No. BGYPW

SITE IDENTIFICATION			
STREET ADDRESS			
Unit/Street No. 52-56		et or property name Parade	
Suburb, town or locality Blacktown NSW			Postcode 2148
Local Government Area(s) Blacktown		Real property description (Lot and D Lots 41, 42 & 43 DP 32163	
ACTIVITY DESCRIPTION			
Provide a description of the activ	rity		
Demolition of 3 existing dwelling	re and e	tructures and the construction of 12	independent living

Demolition of 3 existing dwellings and structures, and the construction of 12 independent living seniors housing units comprising 6 x 1 bedroom and 6 x 2 bedroom units, with associated landscaping and fencing, surface parking for 6 cars, and consolidation into a single lot.

The Land & Housing Corporation (LAHC) has proposed the above activity under the provisions of *State Environmental Planning Policy* (Housing) 2021 (Housing SEPP) which requires determination under Part 5 of the *Environmental Planning & Assessment Act* 1979 (EP&A Act). This Decision Statement relates to the Review of Environmental Factors (REF) for the above activity prepared under Part 5 of the EP&A Act and the *Environmental Planning and Assessment Regulation 2021*.

Based on the REF document and supporting documentation, including advice from Blacktown City Council a decision to proceed with the proposed activity has been made. This decision included consideration of the following:

Significant Impact on the Environment

- The proposed activity is not likely to have a significant impact on the environment and therefore an EIS is not required.
- The proposed activity will not be carried out in a declared area of outstanding biodiversity value and is not likely to significantly affect threatened species, populations or ecological communities, or their habitats or impact biodiversity values, meaning a SIS and/or BDAR is not required.

Reasons for the Decision

• Following an assessment of the proposed activity and associated environmental impacts within the REF document it was decided that the proposed seniors housing will have economic and social benefits and any minor short-term impacts on the environment or surrounding properties can be appropriately mitigated.

• The proposed seniors housing will assist LAHC in providing new, fit for purpose housing in the Blacktown local government area which will assist in addressing the existing and growing demand for accommodation in this local government area.

Mitigation Measures

• Mitigation measures are required to minimise or manage environmental impacts and are detailed throughout the REF and specifically within Section 8. All mitigation measures are detailed as Identified Requirements within the Activity Determination. Additional mitigation measures, detailed in the Activity Determination have been imposed to minimise the impact on the surrounding environment, ensure appropriate site safety and ensure legislative compliance.

Kerta

Signed.....

Dated...^{20 December 2023}

Emma Nicholson Acting Head of Policy and Innovation Land and Housing Corporation Department of Planning & Environment

PART 5 SENIOR HOUSING DEVELOPMENT

BLACKTOWN SENIOR HOUSING

52-56 PANK PARADE, BLACKTOWN LOT 41, 42 & 43 IN DP 32163

Housing SEPP 2021

External works

- Units on ground floor level to be linked by an AS1428.1 compliant accessible path to the adjoining road.

- Pathway lighting to be Glare free for pedestrians and dwelling and must provide at least 20 lux at ground level.

- Letterboxes must be provided on a hard-standing area, lockable and have wheelchair circulation (1550mm diameter) and linked via an accessible path as per AS1428.1

- There should be no step to the main entry door, entry to external verandah that contain clothes line and between path from street to the verandah. A max threshold of 35mm is permitted where a threshold ramp is provided.

- A garbage storage area must be provided in an accessible location. Provide 1550mm circulation spaces in front of bins

Carparking

- Car parking to comply with AS2890.6.

Doorway requirements

- Main entry door, door to courtyards, main accessible bathroom, laundry to be 850mm clear (920mm min door leaf) with door circulation spaces as per AS1428.1. All other doors to have 850mm clear opening with scope of provision of door circulation in the future.

- Door handles and hardware for all doors must be provided in accordance with AS 4299 with single hand operation, lever style, operation located between 900-100mm above FFL and all external doors to be keyed alike.

Bedroom requirements

- Main bedroom to have size of queen bed with 1,200mm wide at the foot of the bed, and 1,000mm wide beside the bed between it and the wall, wardrobe or any other obstruction.

Electrical requirements

- Bedroom must have a telephone outlet next to the bed on the side closest to the door and a general power outlet beside the telephone outlet.

- Bedroom must have wiring to allow a potential illumination level of at least 300 lux.

- Switches and power points must be provided in accordance with AS 4299 with switches located between 900-1000mm and in line with door handles, (Rocker action / toggle / push pad switches with 35mm width are preferred) and GPOs to be at least 600mm above FFL (1000mm

preferred) and not less than 500mm horizontally from internal corners. - Living room, must have a telephone adjacent to a general power outlet and Living and dining room must have wiring to allow a potential illumination level of at least 300 lux.

Laundry / Linen cupd

- Laundry must have the provision for the installation of an automatic washing machine and a clothes dryer, a slip-resistant floor surface and an accessible path to clothes line is to be provided.

- At least 1 linen cupboard is to be provided with 600mm minimum width and adjustable shelving Main bathroom

- Bathroom must be Slip-resistant floor surface.

- Bathroom must have shower as per AS1428.1 without a hob, waterproofed to AS 3740, floor falls to waste, walls reinforced to accommodate grabrails / folding seat in the future, taps to be lever or capstan with single outlet, taps to be easily reached from shower entry, wall cabinet that is sufficiently illuminated, and a double general power outlet beside the mirror.

- All tiled areas such as bathrooms, kitchen, and laundries to be such that there is no lip at the doorway. Recess the concrete slab at wet areas if required for compliance.

Kitchen

- Kitchen fittings must be provided as per Clause 4.5 of AS 4299:

- 800mm wide work surface which is adjustable or replaceable as a unit at variable heights within range of 750mm to 850mm above FFL in between the wall oven and cooktop.

- Tap set with capstan or lever handles with the taps or operating handles to be located 300mm from front of the sink

- Cooktops with front or side controls with raised crossbars, isolating switch and a work surface of 800mm length at the same height

- Wall oven located next to adjustable height work bench minimum 820mm width.



52-56 PANK PARADE, BLA This is a summary of the BASIX commitments as detailed in the BASIX cent	
BASIX COMMITMENT	S SUMMARY
RESIDENTIAL U	NITS
WATER COMMITMENTS	
Fixtures	
All Showerheads	4 Star
All Toilets Flushing Systems	3 Star
All Kitchen Taps	4 Star
All Bathroom Taps HW Recirculation or Diversion?	4 Star
	No
Appliances	
All Dish Washers / Clothes Washers	N/A
Alternative Water Source	
Central Water Tank	Landscape, Toilet Connection ONLY
ENERGY COMMITMENTS	
Hot Water	
Hot Water System	Gas Instantaneous 4 Star
Bathroom Ventilation	
Each Bathroom	Individual Fan, Ducted to Facade/Roof
Operation Control	Manual Switch On / Off
Kitchen Ventilation	
Each Kitchen	Individual Fan, Ducted to Facade/Roof
Operation Control	Manual Switch On / Off
Laundry Ventilation	
Each Laundry	Individual Fan, Ducted to Facade/Roof
Operation Control	Manual Switch On / Off
Cooling & Heating	
Cooling	Ceiling Fans at Living & Bedrooms
Heating	N/A
Artificial Lighting	
Bedrooms, Living Areas, Kitchen, Bathrooms/Toilets, Laundry, Hallways	Yes
Natural Lighting	
Number of Bathrooms	1 in Unit 01, 05, 06, 07, 11 & 12
Kitchen	Yes in Unit 01, 06, 07 & 12
Appliances	
Kitchen Cooktop/Oven	Gas Cooktop and Electric Oven
Well Ventilated Fridge Space	No
Dish Washer	N/A
Clothes Washer / Clothes Dryer	N/A
Private Outdoor or Unsheltered Clothes Drying Line	Yes


BASIX COMMI	TMENTS SUMMARY
СОМ	MON AREAS
WATER COMMITMENTS	
Showerheads	No Common Facility
Toilets	No Common Facility
Taps	No Common Facility
Clothes Washer	No Common Facility
ENERGY COMMITMENTS	
Ventilation	
Common Area Ventilation	No Mechanical Ventilation
Lighting	
Primary Type of Artificial Lighting	LED
Lighting Efficiency Measure	Daylight Sensor and Motion Sensor
Light Control System /BMS	No
Central Systems	
Central Water Tank - Rainwater or Stormwater	Size: 7000
Alternative Energy Supply	L.
Photovoltaic System	Rated Electrical Output (min): 3.0 peak kW
·	
NatHERS COMMITMEN R4.5 insulation to ceiling	NTS SUMMARY

- R2.5 External Wall Insulation
- Roof type : Metal Roof : Medium Colour (SA 0.475 0.7) + 55mm Foil Blanket R1.3
- External Glazing: Aluminium standard single-glazed: clear glass: U = 6.70 & SHGC = 0.70
- All External door and windows to be weather sealed Exhaust Fans / Downlights to be sealed (if any)
- Eaves and Shading as per drawings

SUBJECT SITE: 52-56 PANK PARADE, BLACKTOWN

SHEET LIST

No.	Name	Current Revision
0000	COVER SHEET	P
0001	LEGENDS / NOTES	M
0002	3D VIEW & DEVELOPMENT DATA TABLE	R
0003	3D VIEWS	L
0004	SITE ANALYSIS	Н
0005	BLOCK ANALYSIS PLAN	Н
0100	SITE PLAN	0
0500	DEMOLITION PLAN	L
1000	GENERAL ARRANGEMENT PLAN - GROUND LEVEL	S
1001	GENERAL ARRANGEMENT PLAN - FIRST LEVEL	Q
1002	GENERAL ARRANGEMENT PLAN - ROOF	N
2000	ELEVATIONS	N
2100	SECTIONS	М
4100	DOOR & WINDOW SCHEDULES	М
8000	PHOTOMONTAGE - SHEET 1	G
8001	PHOTOMONTAGE - SHEET 2	G
8100	SOLAR ANALYSIS	N
8200	SOLAR STUDY - SHEET 1	1
8201	SOLAR STUDY - SHEET 2	1

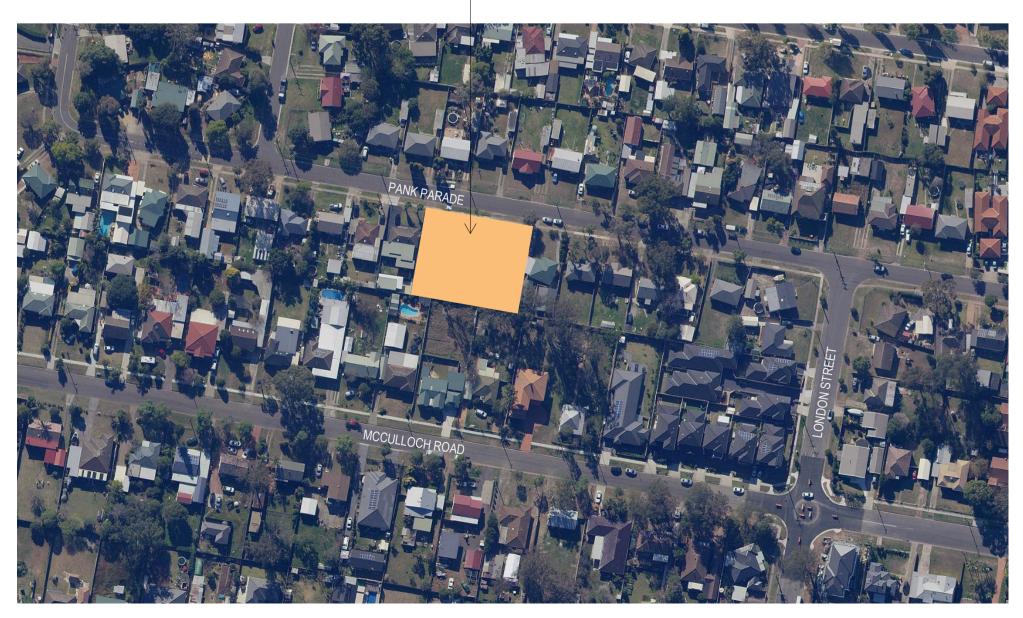

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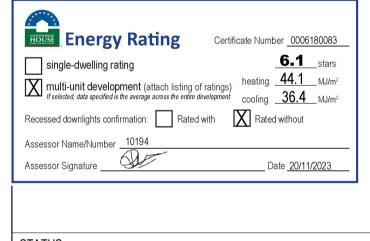
20 December 2023

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AMENDMENTS

REV	DESCRIPTION	AUTH	CHK	DATE
Н	DRAFT PART 5	VL	KM	04.11.22
I	DRAFT PART 5	VL	KM	09.11.22
J	PART 5	VL	KM	16.11.22
K	PART 5	VL	KM	21.11.22
L	PART 5	BB	MW	31.05.23
М	PART 5	BB	MW	13.06.23
Ν	PART 5	BB	MW	17.07.23
0	PART 5	BB	MW	12.10.23
Р	PART 5	BB	MW	16.11.23



STATUS PART 5



SYDNEY Level 5, 111-117 Devonshire St Surry Hills NSW 2010 T +61 2 8396 9500

LAHC

syd@modedesign.com.au

ABN: 65 112 807 931

CLIENT

BLACKTOWN SENIOR HOUSING 52-56 Pank Parade, Blacktown Lots 41, 42 & 43 DP32163 DRAWING TITLE

COVER SHEET

DRAWN		CHECKED		
VL		KM		
ISSUE 16/11/2023 1:27:18 P	M	SCALE @ A1 NTS	SCALE NTS	@ A3
PROJECT No	STAGE	DRAWING No		REVISION
22032	DA	AR-	0000	Ρ

<u>SYMBOLOGY</u>

PHASING LEGEND

ABBREVIATIONS LEGEND

BUILDING ELEMENTS	DRAFTING CONVENTIONS	DRA	FTING ABBREVIATIONS	ACOU
DOORS AND WINDOWS D DOOR 0.00a NUMBER W WINDOW 0.00a NUMBER	EXISTING TO REMAIN	AFFL ASFL COS EQ FFL NOM NTS	ABOVE FINISHED FLOOR LEVEL ABOVE STRUCTURAL FLOOR LEVEL CHECK/ CONFIRM ON SITE EQUAL FINISHED FLOOR LEVEL NOMINAL NOT TO SCALE	
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OTHER BUILDING ELEMENTS		Ø	DIAMETER	
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MATERIALS/ FINISHES	DING SYSTEM			
REVISION				
REVISION 22 DESCRIPTION REVISION D				
SETOUT				
GRID 0				
SLOPE → FALL 1:3				
STEP STEP				
REFERENCING				
REFERENCE 2 PLAN XA202 Scale: 1 : 100	DRAWING TITLE			
	DRAWING SCALE			
VIEW NUMBER	DRAWING TITLE			
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REFERENCE AIU SHEET				
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SECTION REFERENCES				
REFERENCE SHEET				

PERFORMANCE REQUIREMENTS

ACOUSTIC PERFORMANCE

ACOUSTIC RATING B
ACOUSTIC RATING C

FIRE & SMOKE PERFORMANCE

••••••SMOKE RATING
FIRE RATING C
FIRE RATING D

TREE LEGEN	<u>o</u>			
TREES TO BE	REMOVED			CC
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	ONE BEDROOM UNIT			BT
LANDSCAPE	LEGEND			
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	DEEP SOIL ZONE			
	PARKING			
$= \frac{1}{\sqrt{2}} \frac{1}{$	DRIVEWAYS			DP
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	SITE SETBACK			
	BALCONY OVER			FS1
	POS			
-W W-	EXISTING SYDNEY W	ATER MAIN		FS2
-S S-	EXISTING SYDNEY W	ATER SEWER MA	IN	
	BENCH			
ABBREVIATIO				GL
AC	AC OUTDOOR CON	DENSER		
BOL COM	BOLLARD COMMS CUPBOARE	h		GTF
CLO	CLOTHESLINE			
D W	DOOR WINDOW			
DP FN	DOWNPIPE COLORBOND FENC	F		GTF
GAS	INSTANTANEOUS G			
GTR LVR	GUTTER EXHAUST LOUVRE			
PIT POS	STORMWATER PIT PRIVATE OPEN SPA			LVR
FIP	FIRE INDICATIVE PA	ANEL		
PWR MIMIC	POWER CPUBOARE MIMIC PANEL)		LVR
MP	METER PANEL			
MSB	MAIN SWITCHBOAR			

HOUSE EEEE	rgy Ratir	Ig Certit	ficate Numb	per 0006180083
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Multi-unit de	evelopment (attacl becified is the average acros	n listing of ratings) is the entire development	heating cooling	
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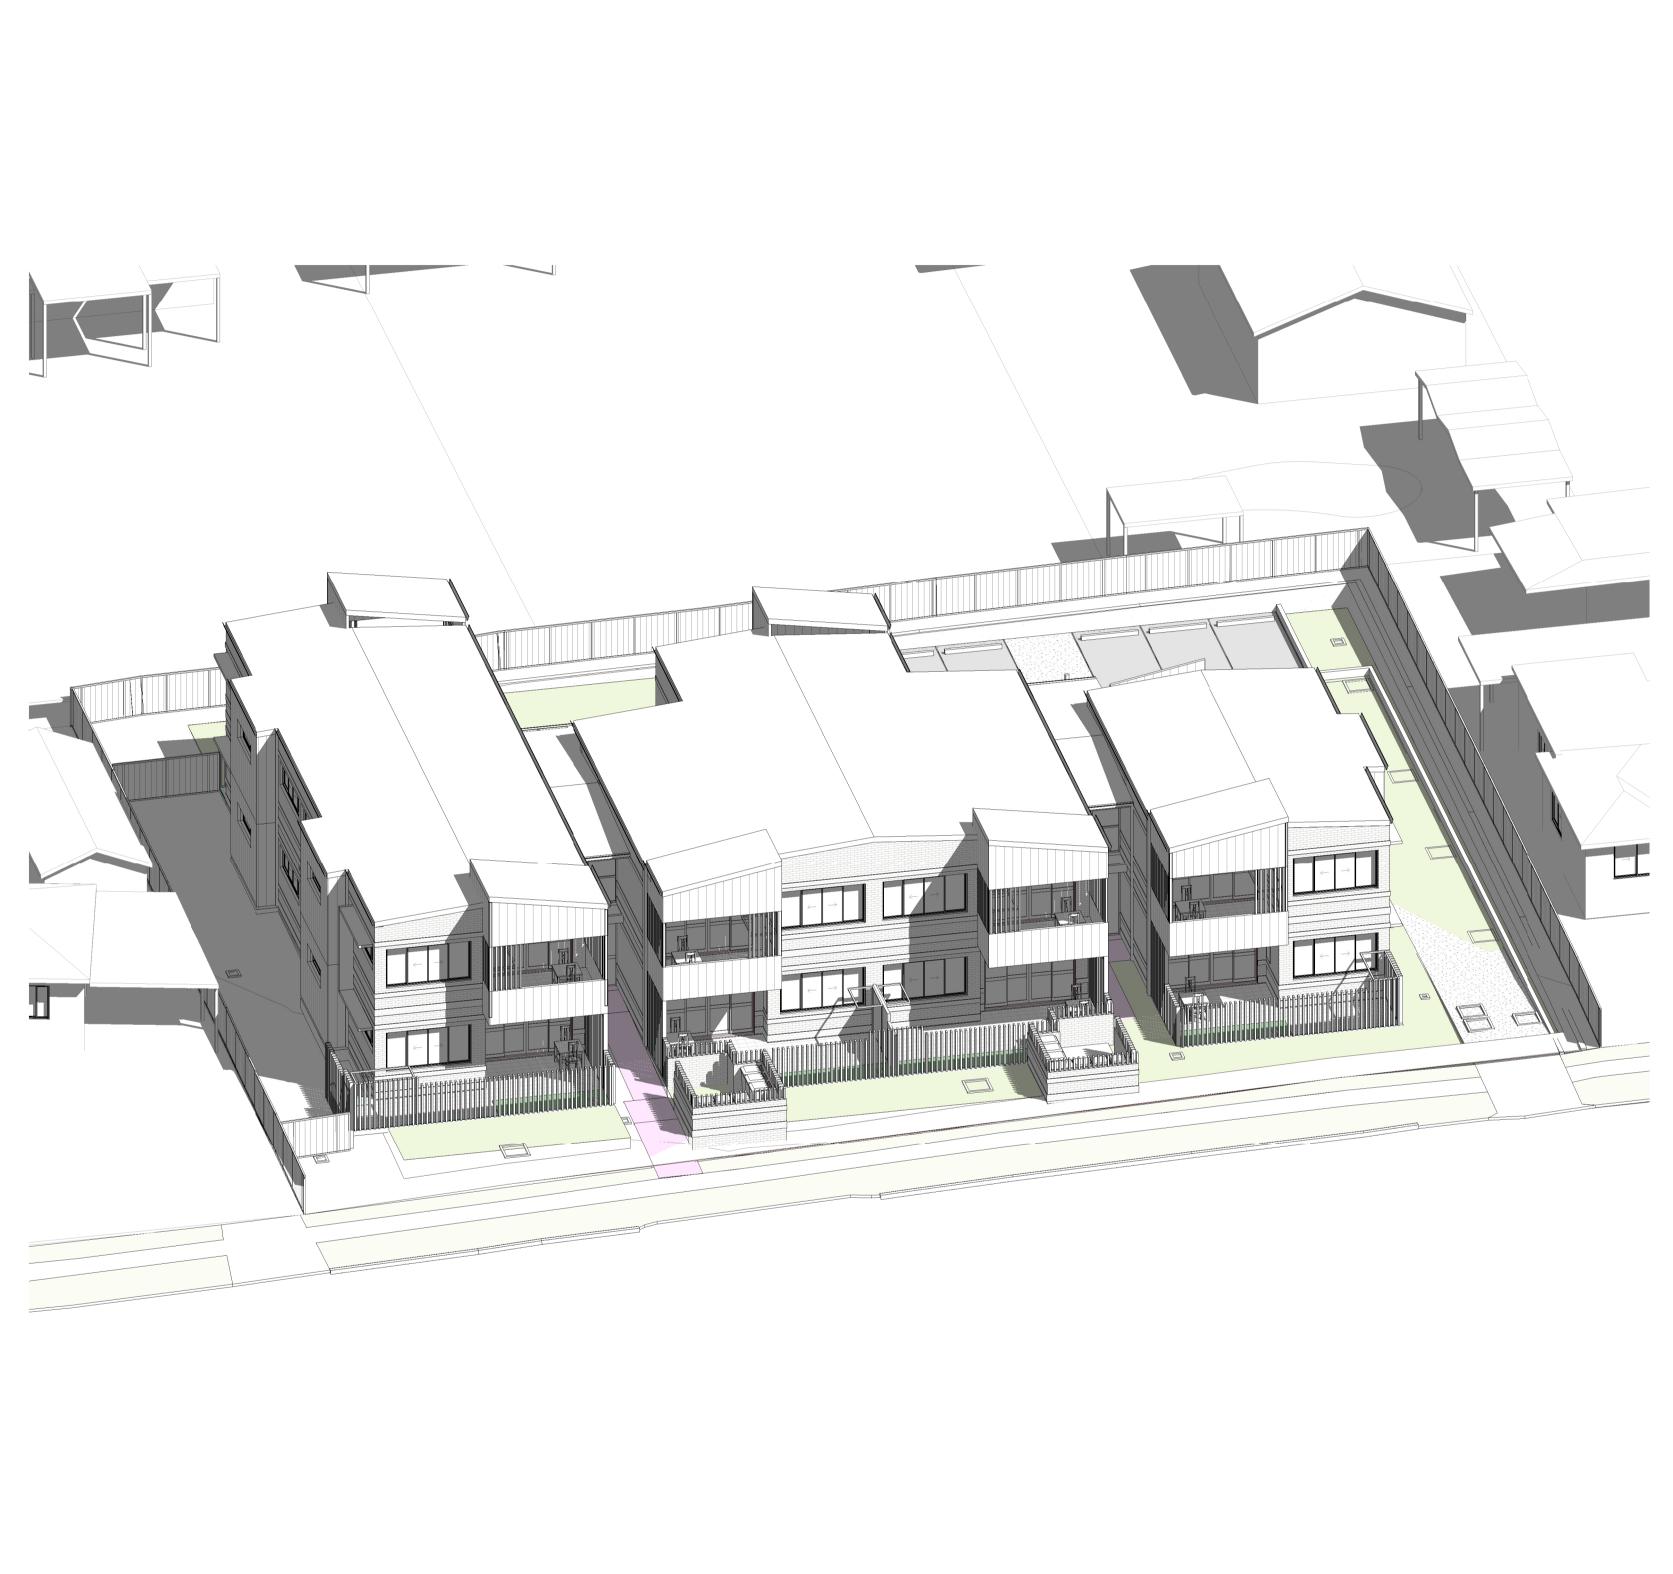
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work.

HES LEGEND	_LEGEND
SCRIPTION	COLOUR
IM COATED: S/DROOS FRAME	COLORBOND MONUMENT
AWNINGS	DULUX ELECTRO GOLD PEARL
СК	AUSTRAL BOWRAL 76 - BRAHMAN GRANITE
СК	AUSTRAL BOWRAL 76 - BOWRAL BLUE
IM BATTEN S	DULUX ELECTRO GOLD PEARL
MENT CLADDING	CEMINTEL BARESTONE
) CONCRETE SLAB	
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OND FENCE	COLORBOND MONUMENT
	COLORBOND SHALE GREY
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	COLORBOND SHALE GREY
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ABOVE DOOR	COLORBOND MONUMENT
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DEVELOPMENT DATA TABLE						
SITE AREA			1670.8 m ²			
NUMBER OF DWELLINGS	12 DWELLINGS - 6 x 1 BED - 6 x 2 BED					
	AUTHORITY		REQUIRED OR ALLOWED	PROPOSED		
FSR	LEP		NOT ADOPTED	NOT ADOPTED		
	HOUSING SEF	P	0.5:1 = 835.4 m ²	0.516:1 = 862 m ²		
HEIGHT	LEP		NOT ADOPTED	NOT ADOPTED		
	HOUSING SEF	PP (CL.42)	9.5m	8.4m		
SETBACK	BLACKTOWN COUNCIL -	FRONT	6m	GROUND LEVEL: 6m BUILDING LINE FIRST LEVEL: 6m BUILDING LINE & 5m BALCONY LINE		
	DCP	SIDE	3m	GROUND LEVEL: 3m BUILDING LINE FIRST LEVEL: 3m BUILDING LINE & BALCONY LINE		
		REAR	6m	GROUND LEVEL: 7.1m BUILDING LINE FIRST LEVEL: 7.1m BUILDING LINE & 6.1m BALCONY LINE		
CAR PARKING	HOUSING SEPP (CL.108) 0.2 x (NO. OF DWELLINGS)		2.4 SPACES	3 SPACES		
	HOUSING SEPP ACCESSIBLE AREA PARKING RATES: 0.4 x (NO. OF 1 BED) 0.5 x (NO. OF 2 BED)		0.4 x 6 (OF 1 BED) = 2.4 0.5 x 6 (OF 1 BED) = 3.0 TOTAL = 5.4	6 SPACES INCLUSIVE OF 3 ACCESSIBLE SPACES		
LANDSCAPING	HOUSING SEF	PP (CL.108)	35 m ² / DWELLING = 420 m ²	542 m ² = 32.4%		
DEEP SOIL	HOUSING SEPP (CL.108) HOUSING SEPP (CL.108)		MIN 15% OF SITE AREA = 250.62 m ² MIN. DIMENSION OF 3M WITH IF PRACTICABLE, MIN 65% OF AREA AT REAR	349 m ² AT REAR = 232 m ² = 66.4%		
PRIVATE OPEN SPACE	HOUSING SEF	PP (CL.108)	GROUND FLOOR DWELLINGS:	COMPLIES		
			NOT LESS THAN 15 m ² WITH MIN 3 x 3 m SIZE ANY OTHER DWELLINGS: 1 BED = 8 m ² 2 BED = 10 m ² NOT LESS THAN 2m IN LENGTH AND DEPTH ACCESSIBLE FROM LIVING ROOMS			
SOLAR ACCESS	HOUSING SEF	PP (CL.108)	70% OF DWELLINGS TO HAVE ACCESS TO DIRECT SOLAR ACCESS FOR A MIN. OF 2 HOURS BETWEEN 9AM AND 3PM MID WINTER TO POS AND LIVING ROOMS	COMPLIES 10 UNITS (3HR) = 83% 11 UNITS (2HR) = 91%		

			PRIVATE OP	EN SPACE	SOL	_AR
UNIT NO.	NO. OF BEDS	AREA (m²)	AREA (m²)	SIZE	LIVING	POS
GROUND LEVEL			GROUND LEVEL			
UNIT 01	2 BEDROOM	77 m²	34 m²	Min 3 x 3m	YES - 3hr	YES - 3hr
JNIT 02	1 BEDROOM	55 m²	27 m²	Min 3 x 3m	YES - 3hr	YES - 3hr
JNIT 03	1 BEDROOM	55 m²	27 m²	Min 3 x 3m	YES - 3hr	YES - 3hr
JNIT 04	1 BEDROOM	55 m²	24 m²	Min 3 x 3m	NO	NO
JNIT 05	2 BEDROOM	77 m²	27 m²	Min 3 x 3m	YES - 3hr	YES - 3hr
JNIT 06	2 BEDROOM	77 m²	16 m²	Min 3 x 3m	YES - 2hr	YES - 2hr
LEVEL 01			LEVEL 01			
UNIT 07	2 BEDROOM	77 m²	12 m²	Min 2m (D)	YES - 3hr	YES - 3hr
JNIT 08	1 BEDROOM	55 m²	10 m²	Min 2m (D)	YES - 3hr	YES - 3hr
JNIT 09	1 BEDROOM	55 m²	10 m ²	Min 2m (D)	YES - 3hr	YES - 3hr
JNIT 10	1 BEDROOM	55 m²	10 m ²	Min 2m (D)	YES - 3hr	YES - 3hr
JNIT 11	2 BEDROOM	77 m²	12 m²	Min 2m (D)	YES - 3hr	YES - 3hr
UNIT 12	2 BEDROOM	77 m ²	12 m ²	Min 2m (D)	YES - 3hr	YES - 3hr
Grand total		790 m ²	218 m ²			

	LEVEL	AREA (m ²)
LOBBY	GROUND LEVEL	16 m²
LOBBY	GROUND LEVEL	20 m ²
LOBBY	LEVEL 01	16 m ²
LOBBY	LEVEL 01	20 m ²
Grand total		72 m²

Energy Rating Certificate Number 0006180083
single-dwelling rating 6.1 stars multi-unit development (attach listing of ratings) heating 44.1 MJ/m² If selected, data specified is the average across the entire development cooling 36.4 MJ/m² Recessed downlights confirmation: Rated with X Rated without
Assessor Name/Number 10194 Assessor Signature Date 20/11/2023



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AMENDMENTS

REV	DESCRIPTION	AUTH	CHK	DATE
J	DRAFT PART 5	VL	KM	02.11.22
K	DRAFT PART 5	VL	KM	04.11.22
L	DRAFT PART 5	VL	KM	09.11.22
М	PART 5	VL	KM	16.11.22
Ν	PART 5	BB	MW	31.05.23
0	PART 5	BB	MW	13.06.23
Р	PART 5	BB	MW	17.07.23
Q	PART 5	BB	MW	12.10.23
R	PART 5	BB	MW	16.11.23

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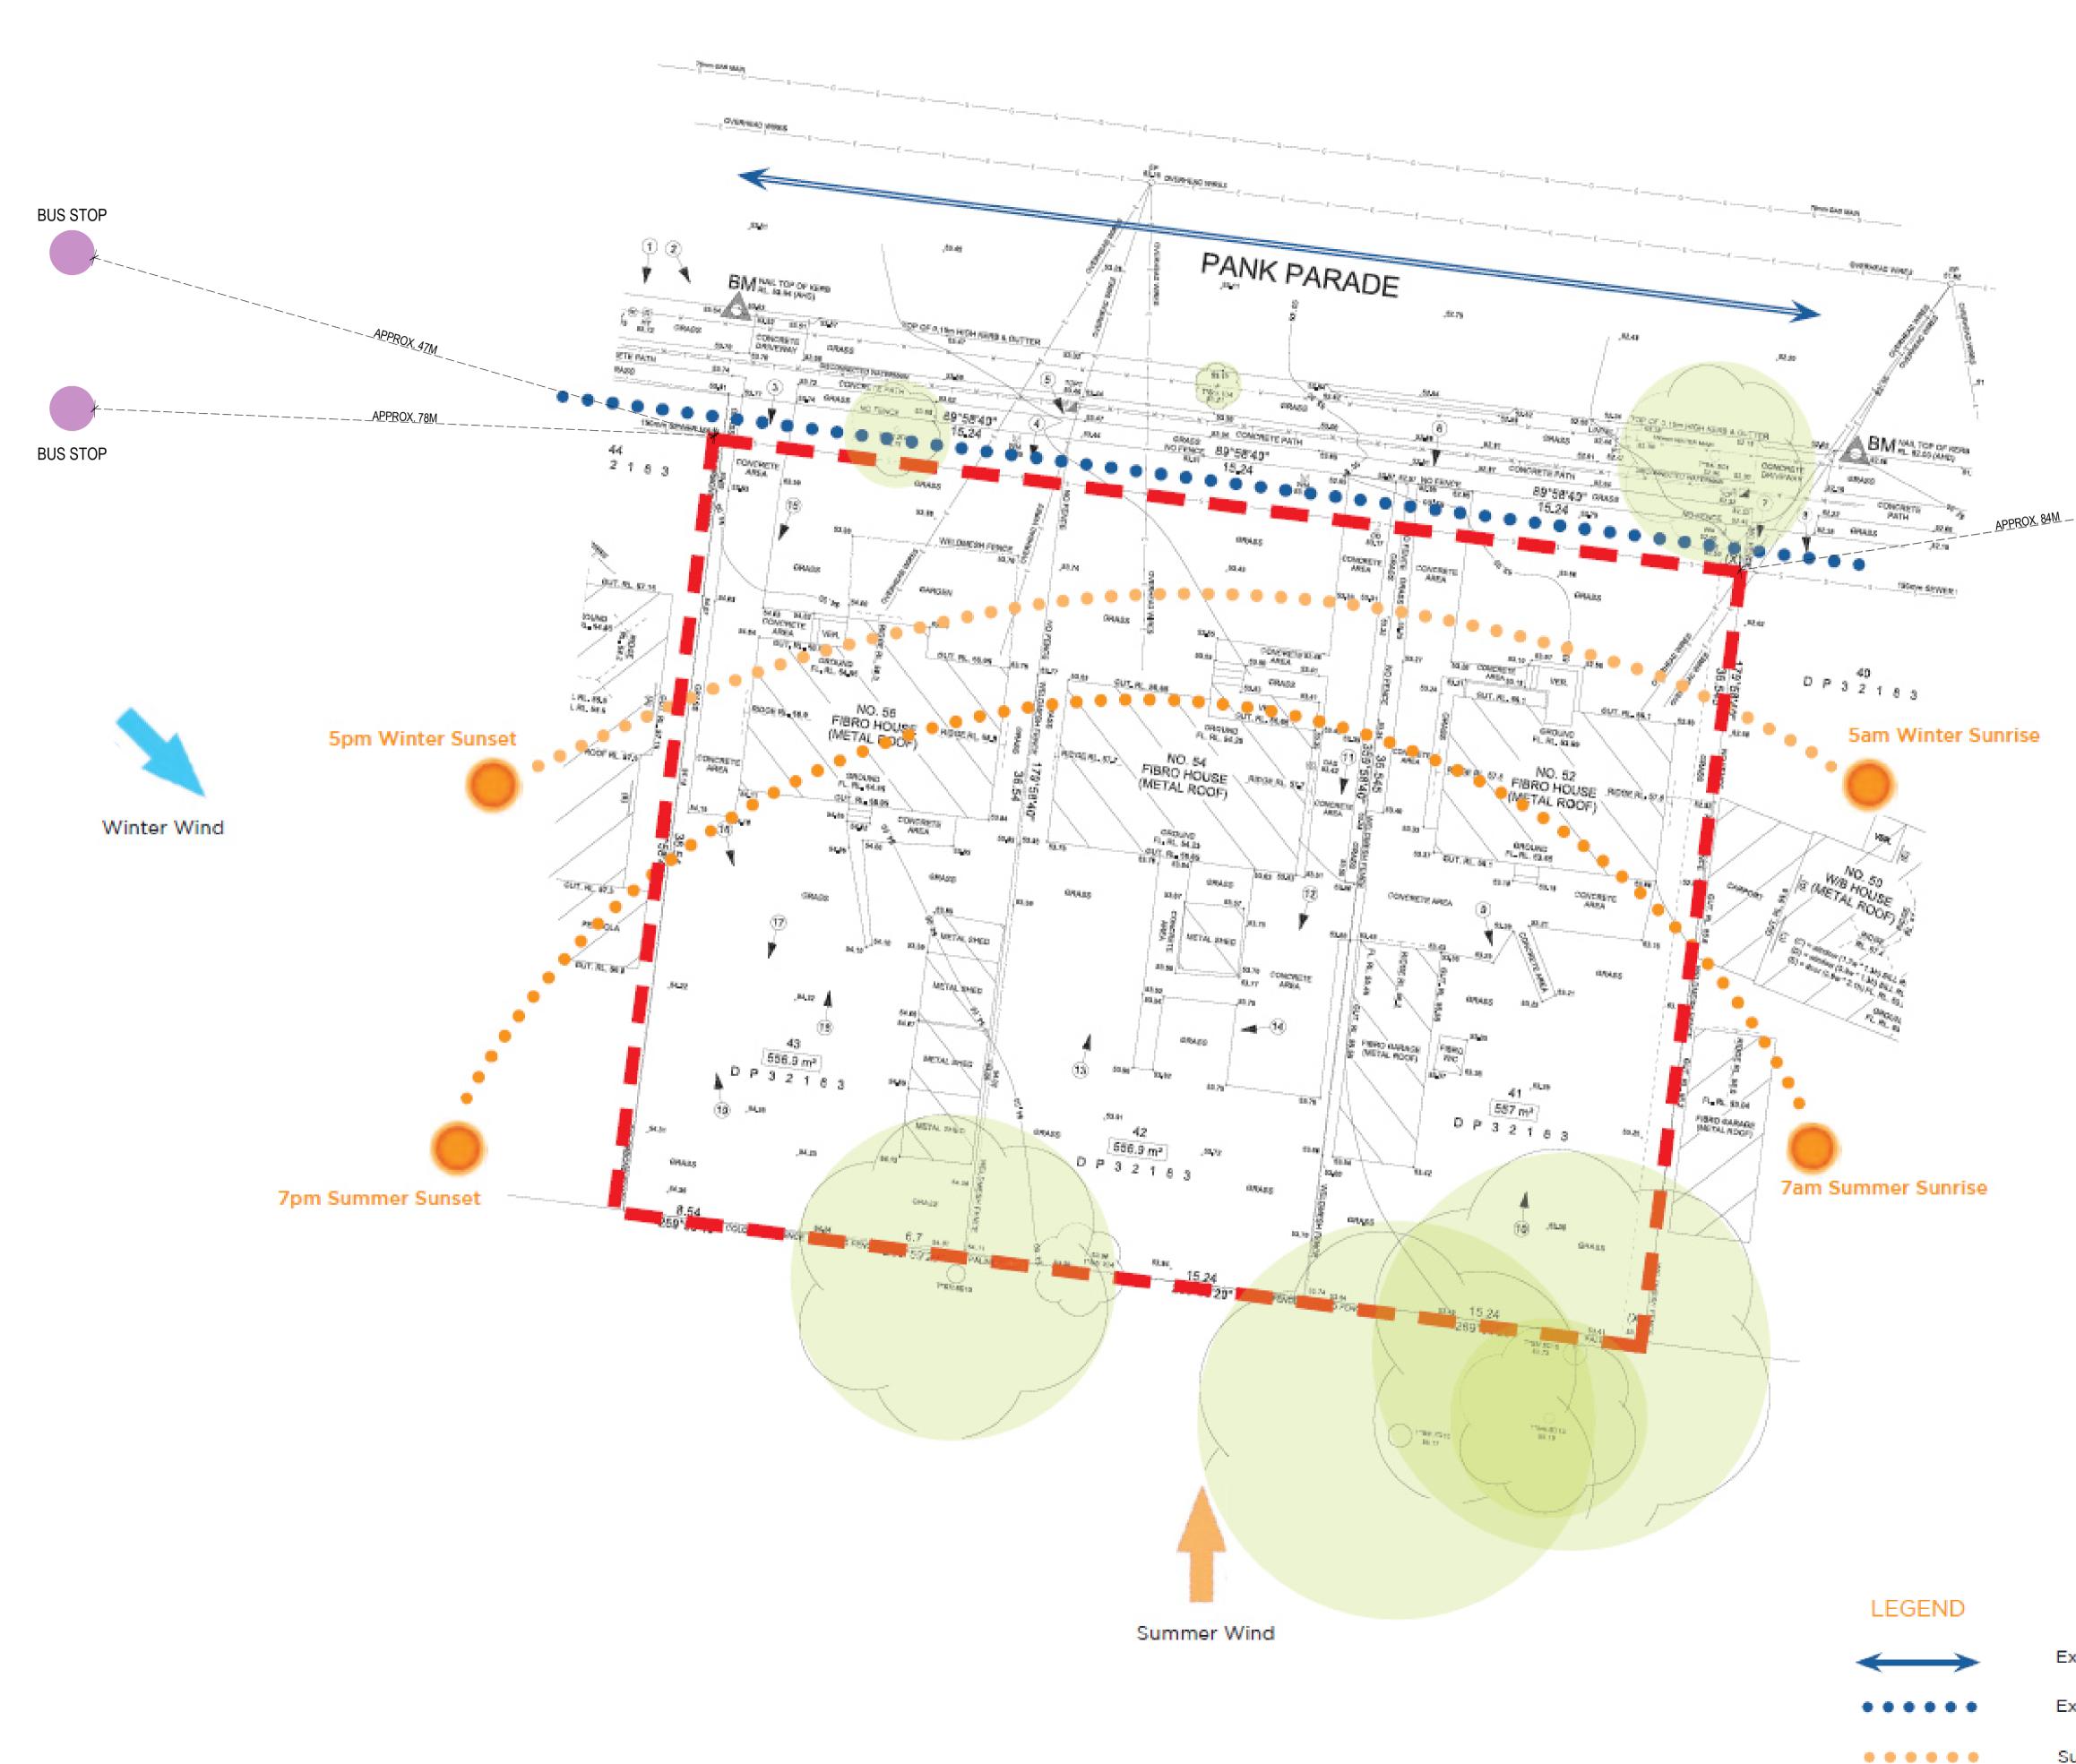
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AMENDMENTS

REV	DESCRIPTION	AUTH	CHK	DATE
D	STAGE B - SKETCH DESIGN	VL	KM	10.10.22
Е	DRAFT PART 5	VL	KM	02.11.22
F	DRAFT PART 5	VL	KM	04.11.22
G	DRAFT PART 5	VL	KM	09.11.22
Н	PART 5	VL	KM	16.11.22
-	PART 5	BB	MW	13.06.23
J	PART 5	BB	MW	17.07.23
Κ	PART 5	BB	MW	12.10.23
L	PART 5	BB	MW	16.11.23





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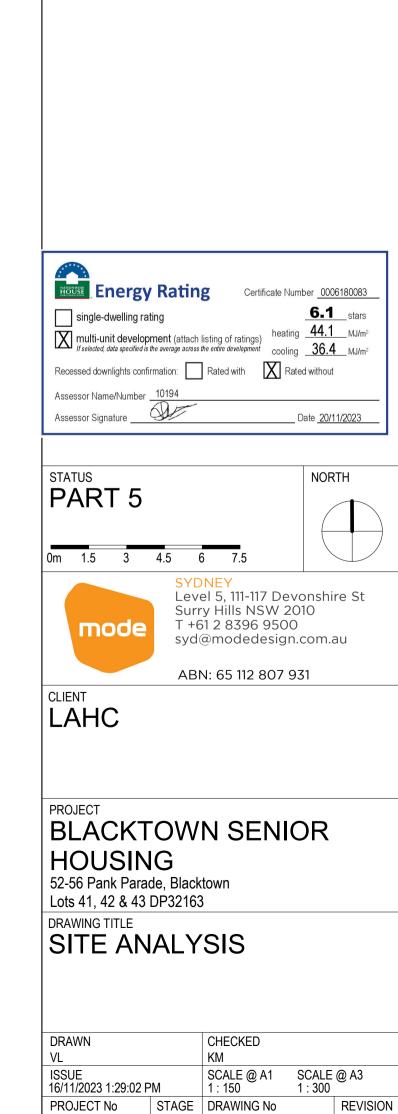
work.

AMENDMENTS

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С	DRAFT PART 5	VL	KM	09.11.22
D	PART 5	VL	KM	16.11.22
Е	PART 5	BB	MW	13.06.23
F	PART 5	BB	MW	17.07.23
G	PART 5	BB	MW	12.10.23
Н	PART 5	BB	MW	16.11.23

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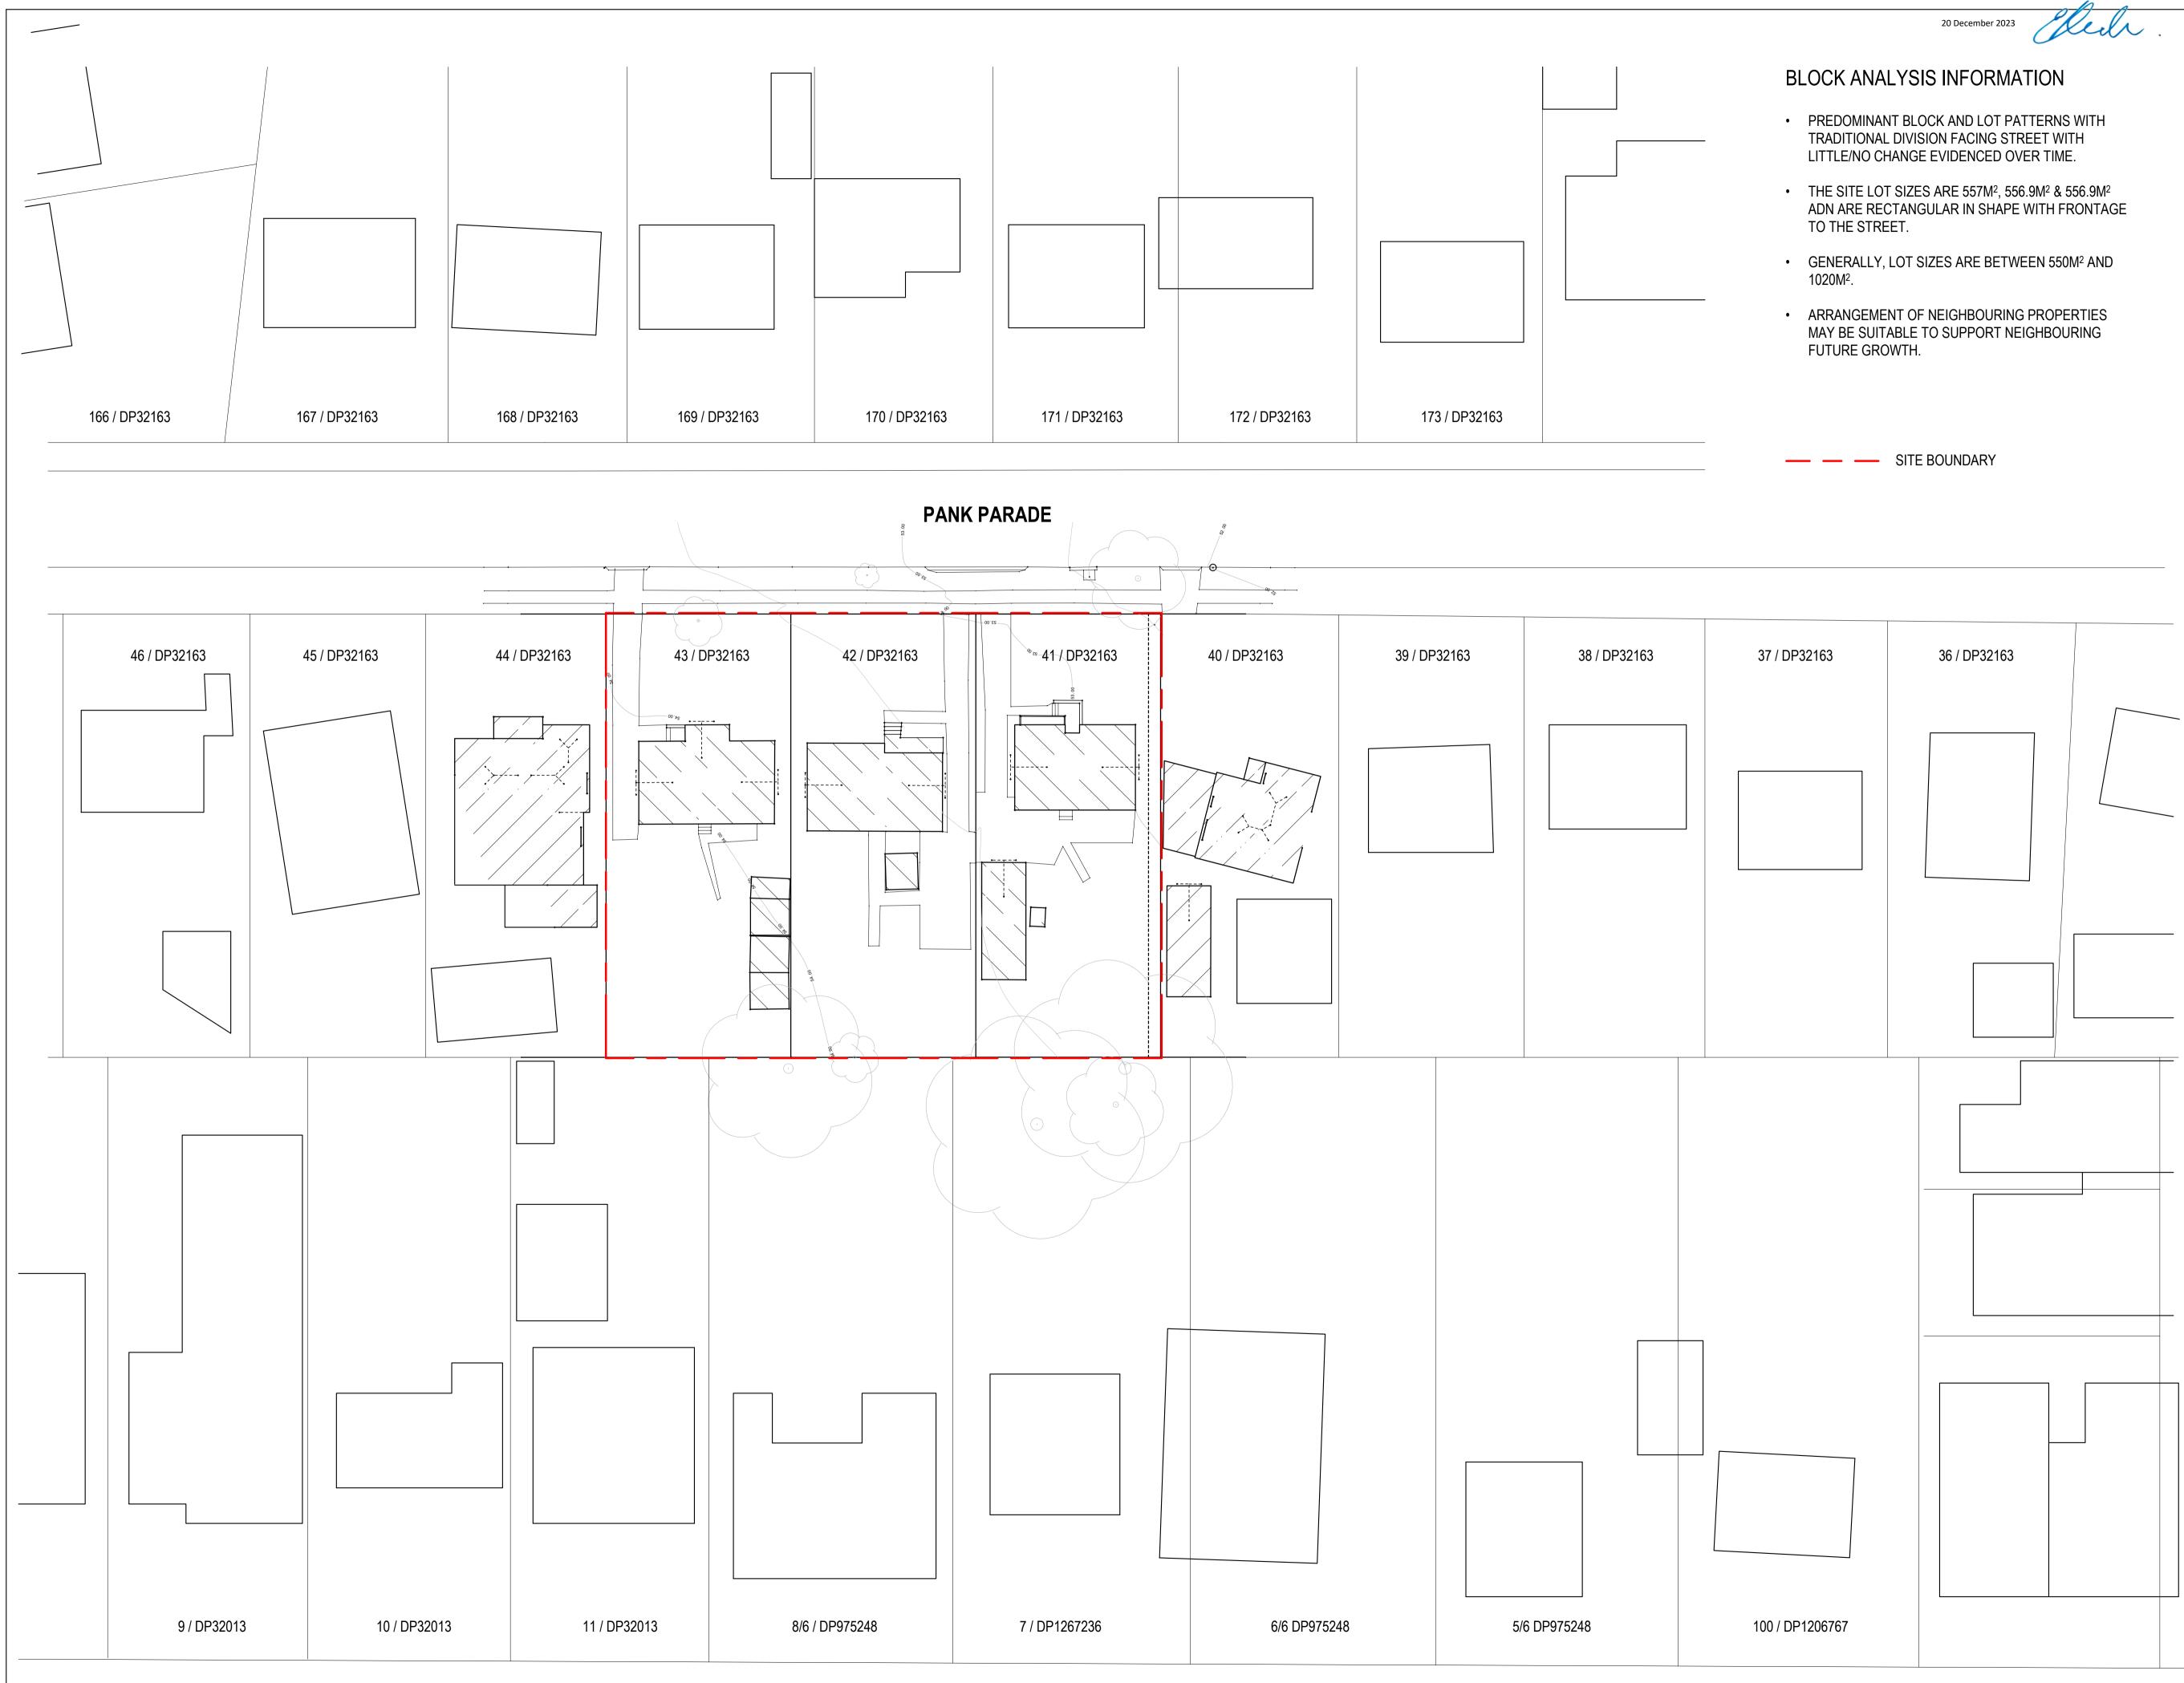
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Existing Vehicular Traffic

Existing Pedestrian movement

Sun path







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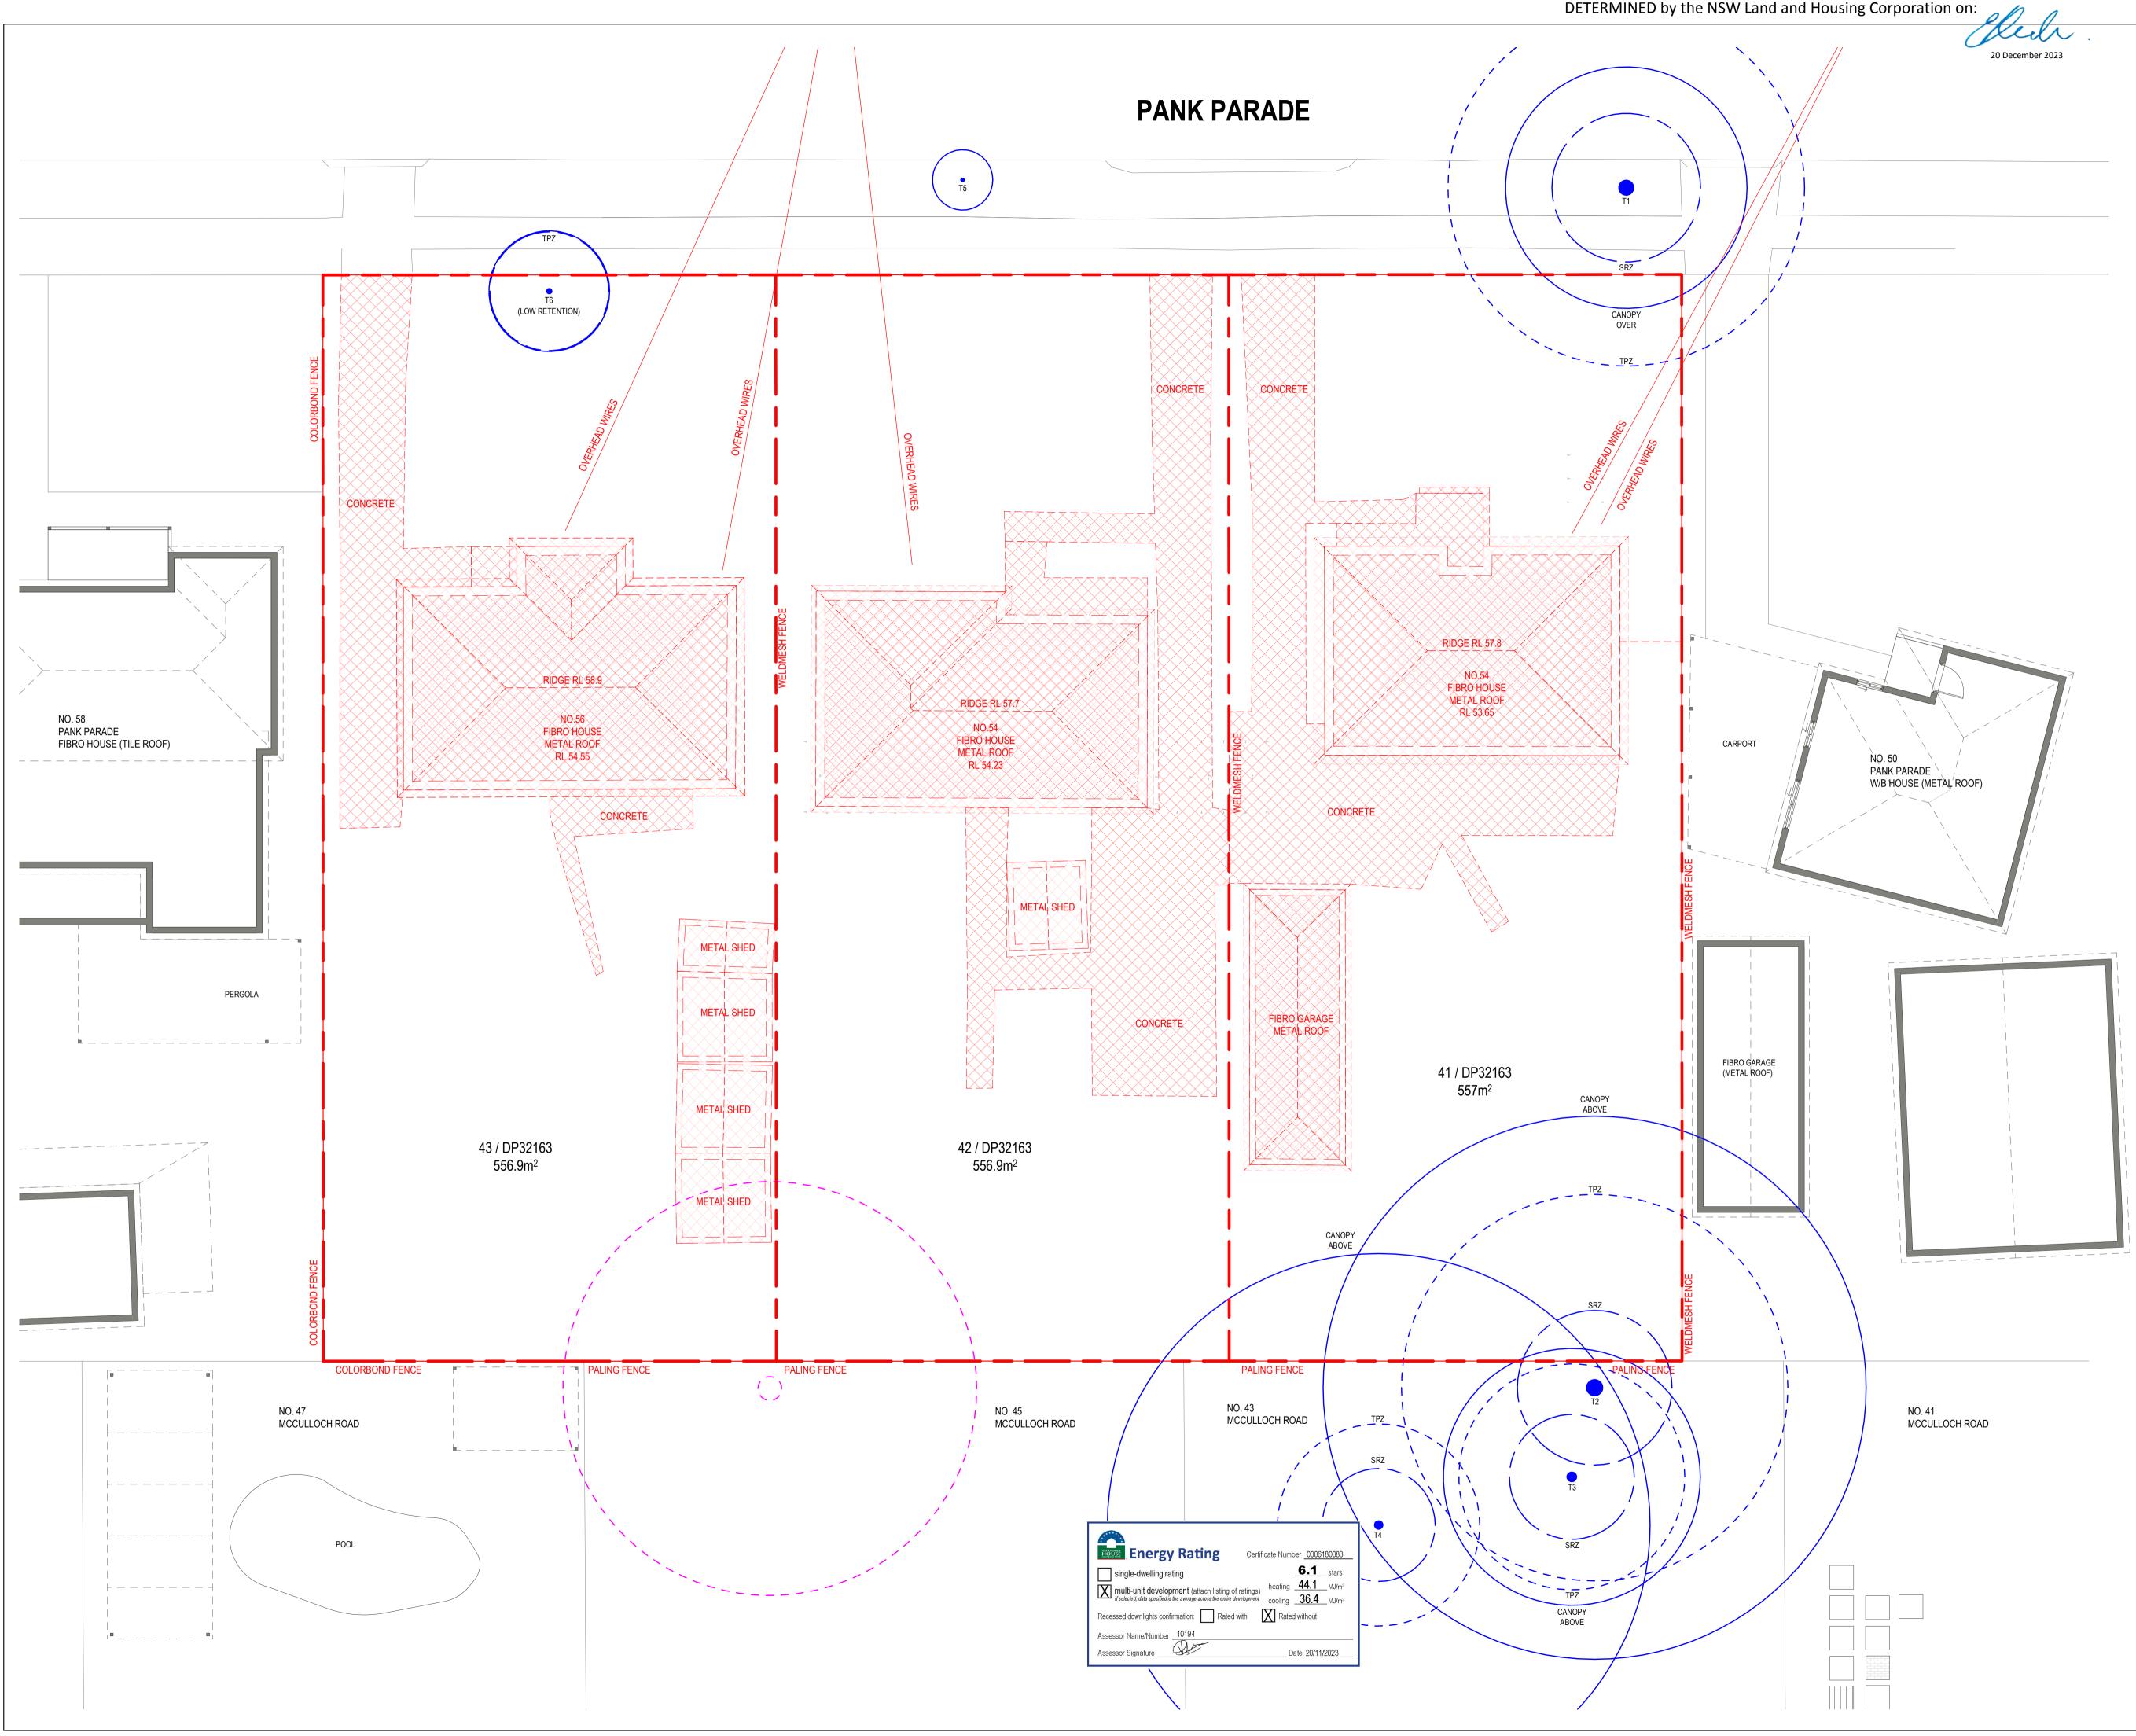
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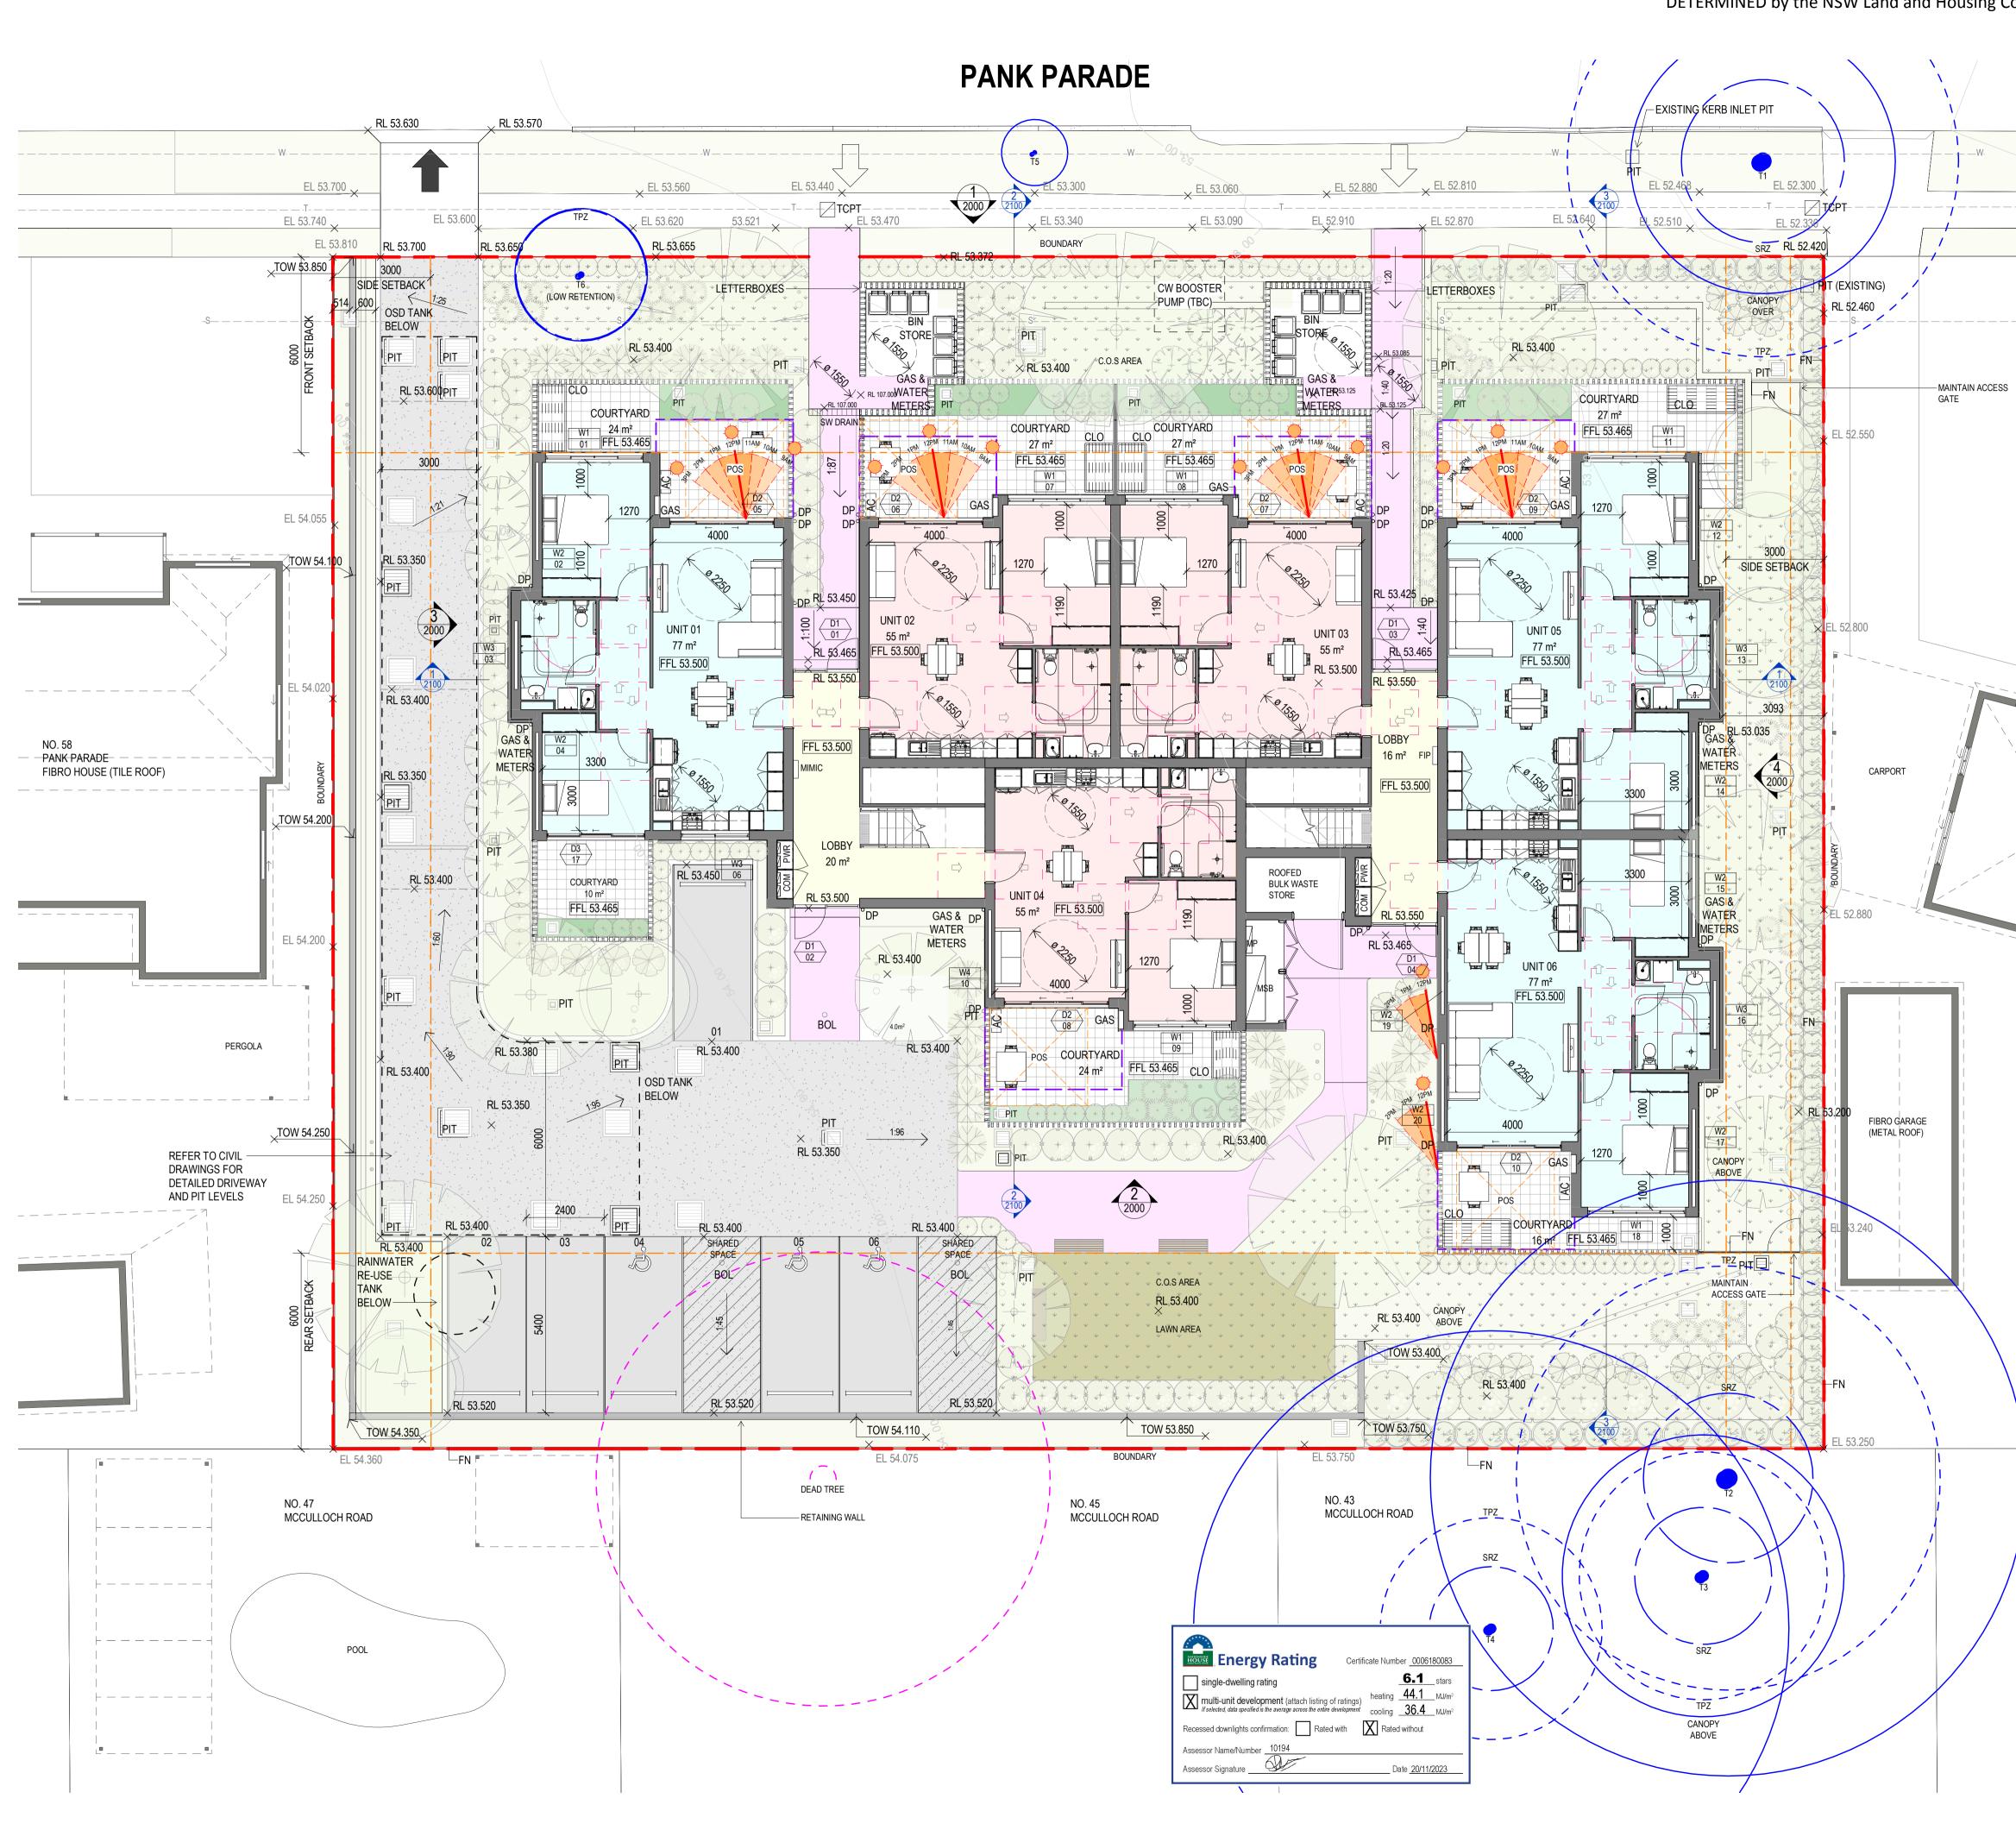
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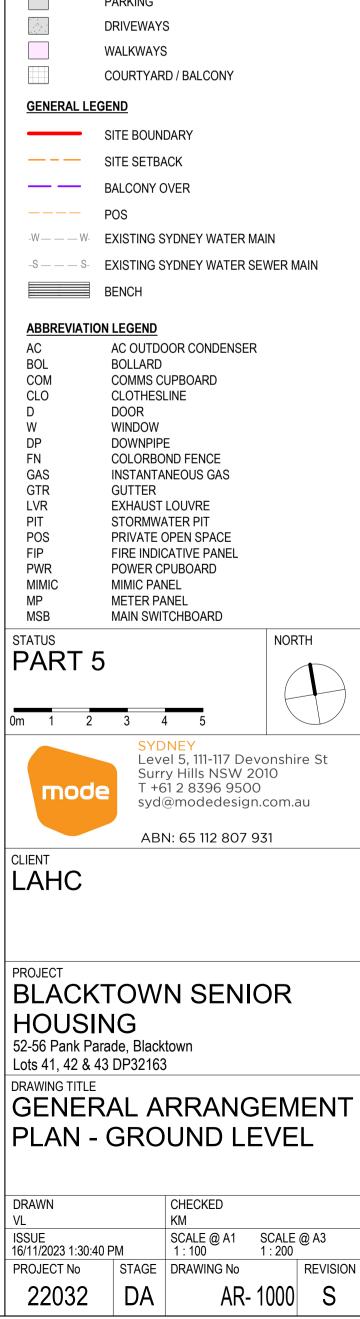



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NO. 50 PANK PARADE

W/BHOUSE (METAL ROOF)

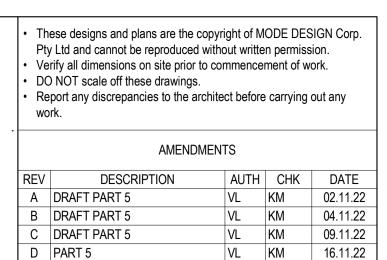NO. 41 MCCULLOCH ROAD



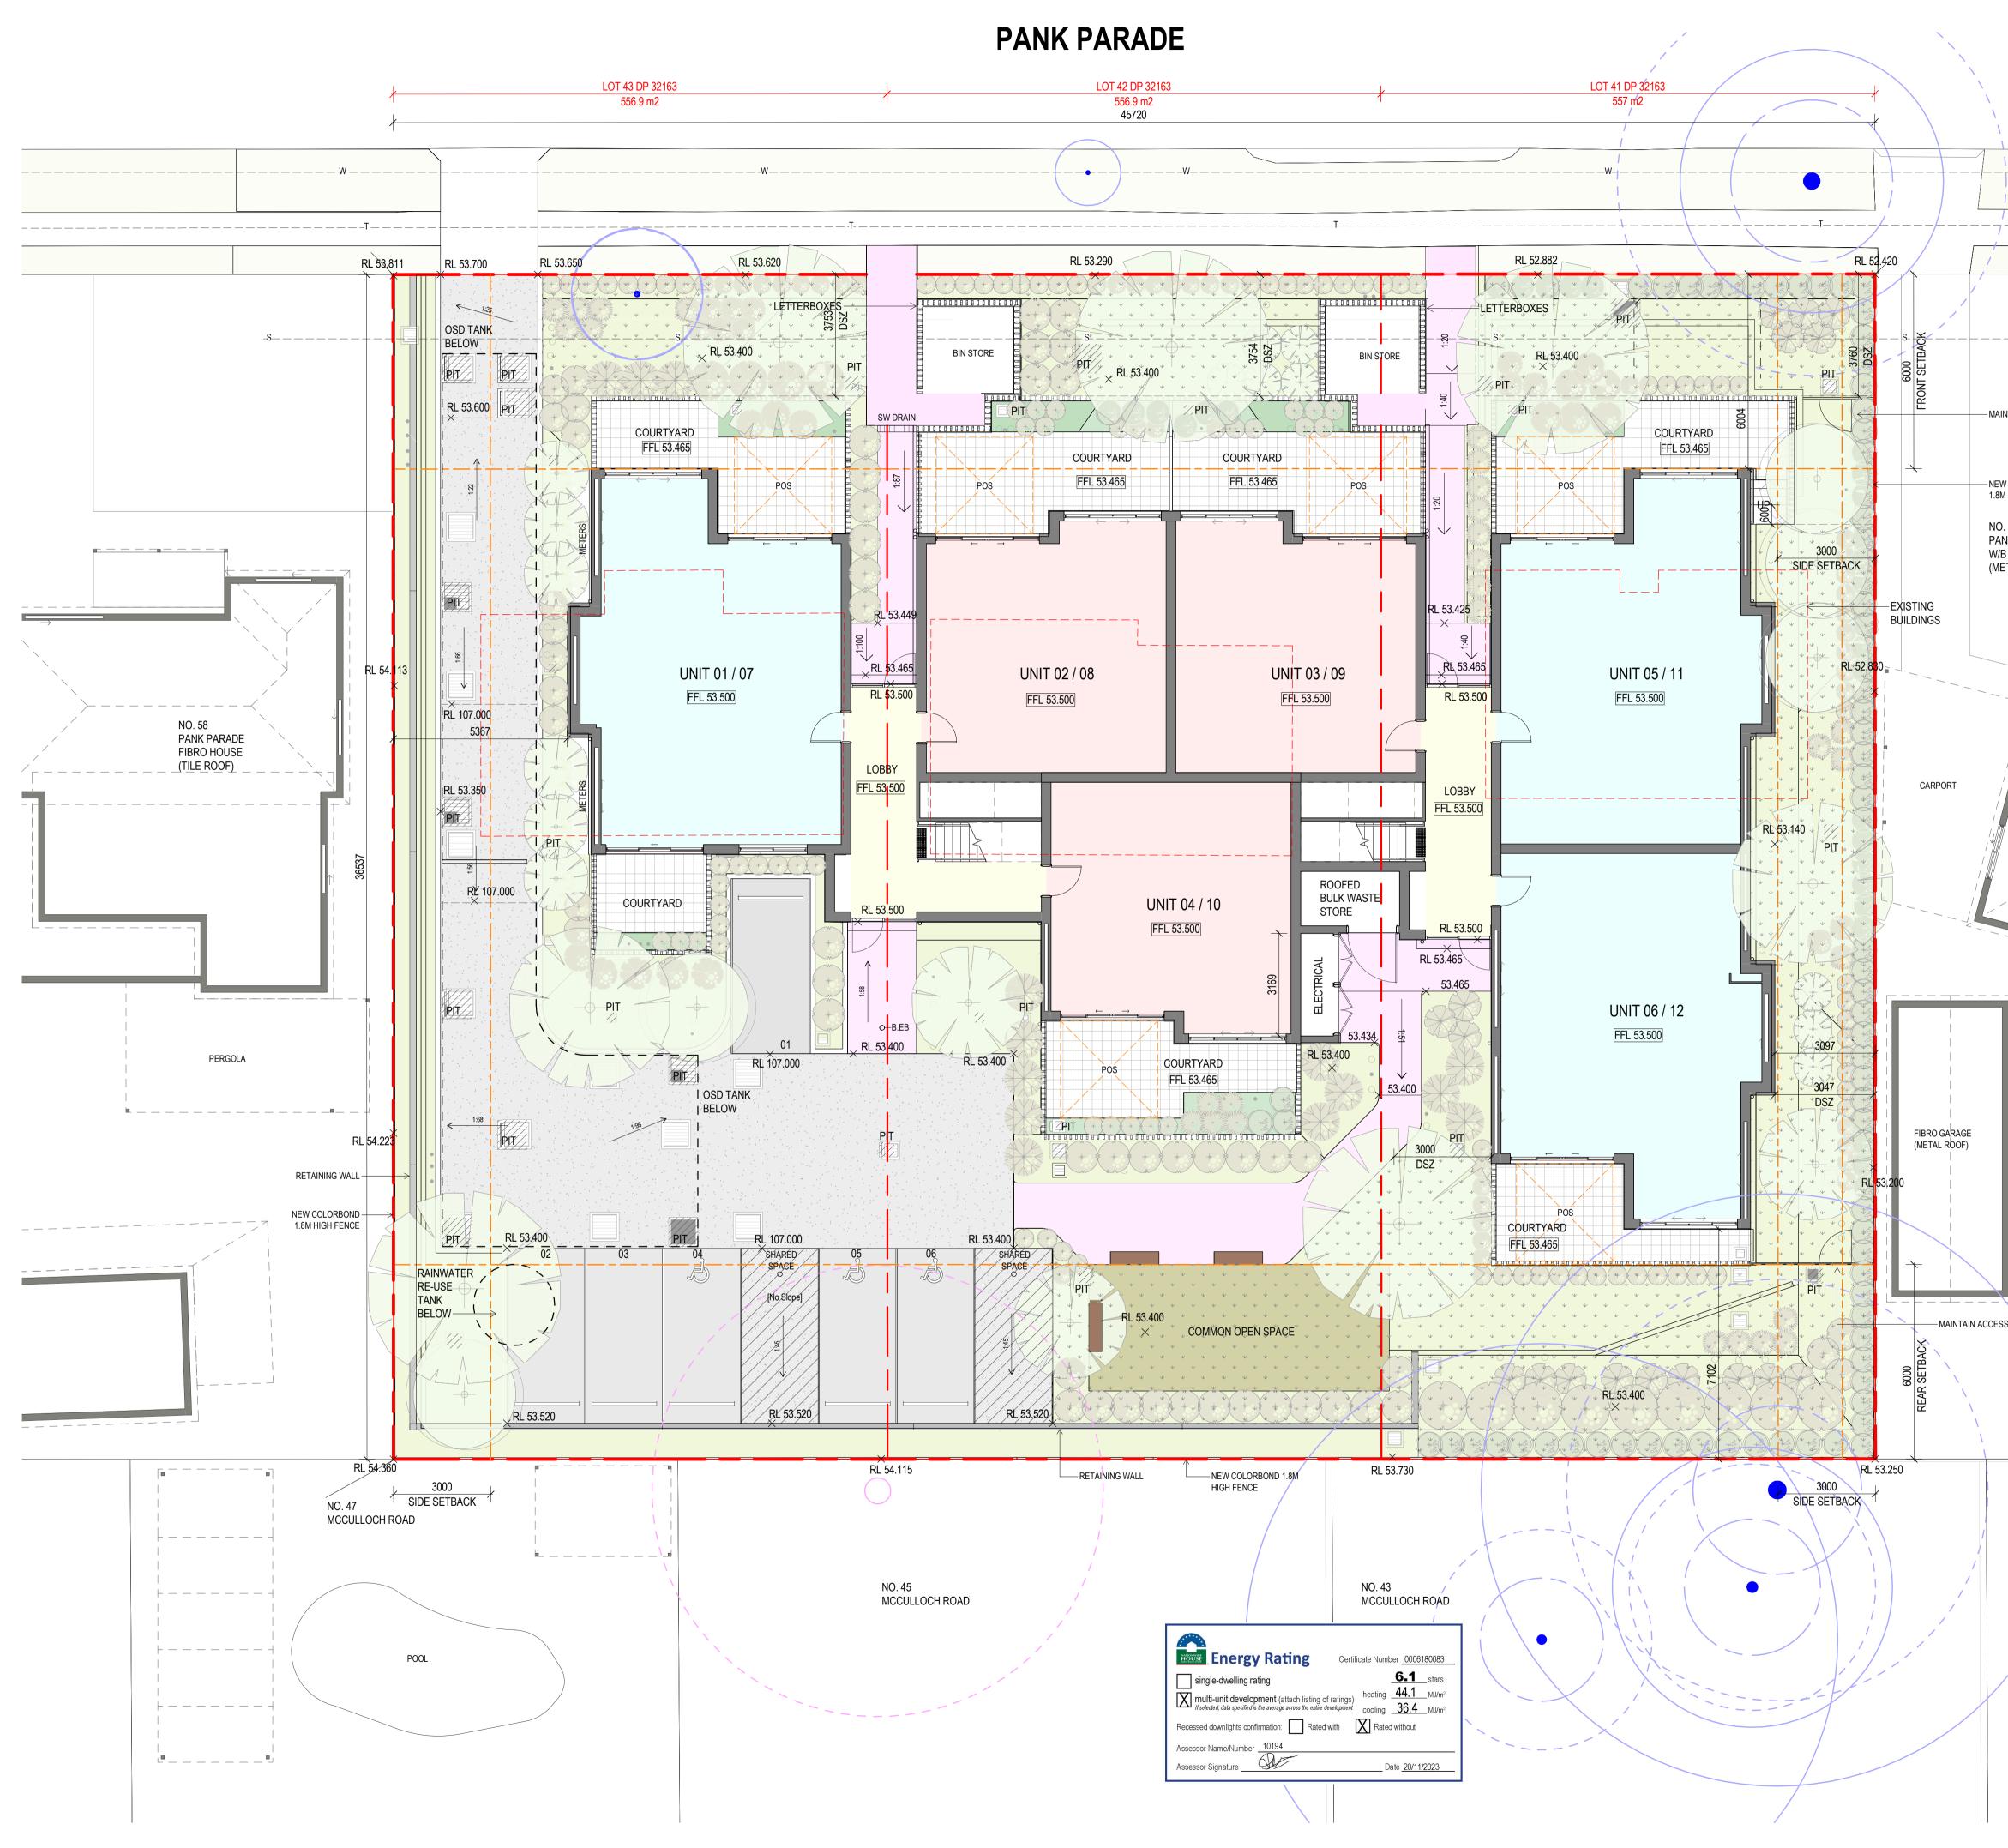


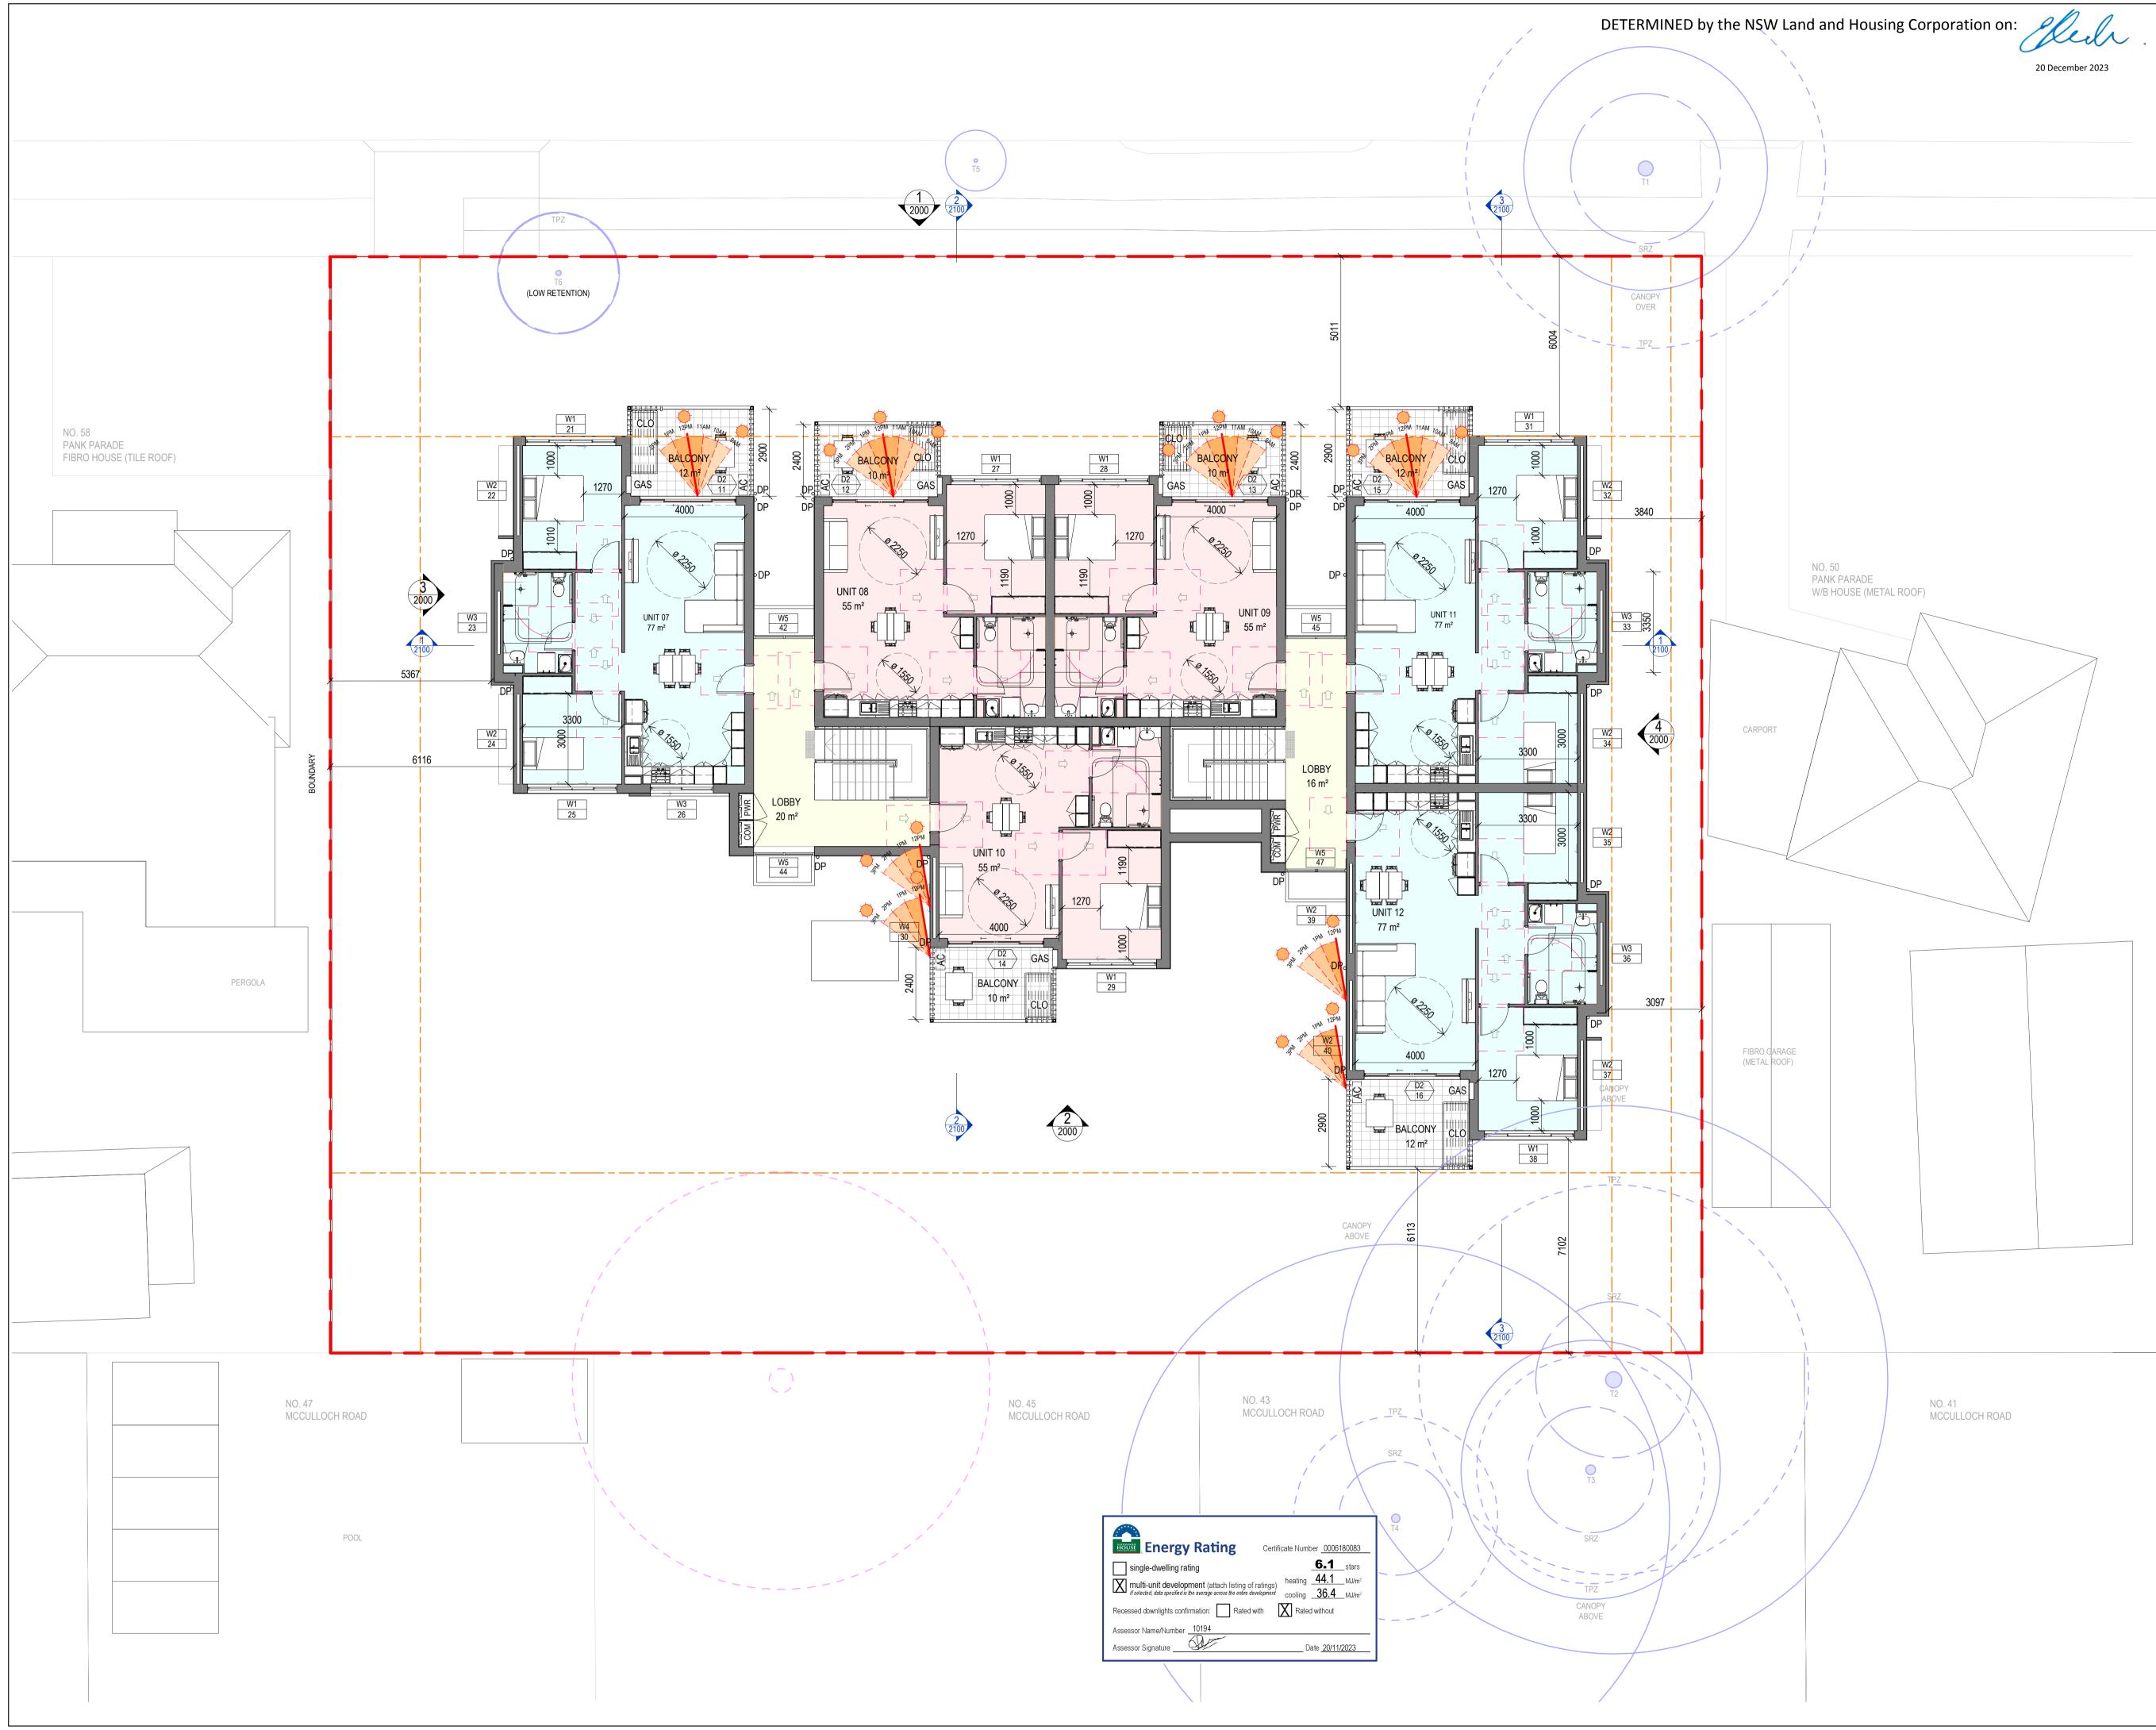

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BALCONY OVER POS W – W EXISTING SYDNEY WATER MAIN S – S EXISTING SYDNEY WATER SEWER MAIN BENCH AC OUTDOOR CONDENSER BOL BOLLARD COM COMMS CUPBOARD CLO CLOTHESLINE D DOOR W WINDOW DP DOWNPIPE FN COLORBOND FENCE GAS INSTANTANEOUS GAS GTR GUTTER LVR EXHAUST LOUVRE PIT STORMWATER PIT POS PRVATE OPEN SPACE FIP FIRE INDICATIVE PANEL PWR POWER CPUBOARD MIMIC MIMIC PANEL MSB MAIN SWITCHBOARD STATUS PART 5 MIMIC MIMIC PANEL MD METER PANEL MSB MAIN SWITCHBOARD SYDNEY Level 5, 111-117 Devonshire St SUMP HILLS SYDNEY Level 5, 112 807 931 CLIENT LAHC	BLACKTOWN SENIOR BLACKTOWN SENIOR HOUSING 52-56 Pank Parade, Blacktown Lots 41, 42 & 43 DP32163 DRAWING TITLE GENERAL ARRANGEMENT DRAWING TITLE ORAWN CHECKED VL KM SCALE @ A1 SCALE @ A3 1: 200 PROJECT No STAGE DRAWING NO REVISIO	VL ISSU 16/11 PRO	JE 1/2023 1:31:38 JECT No	STAGE	SCALE 1 : 100	NG No	1 : 200	REVISI




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work.

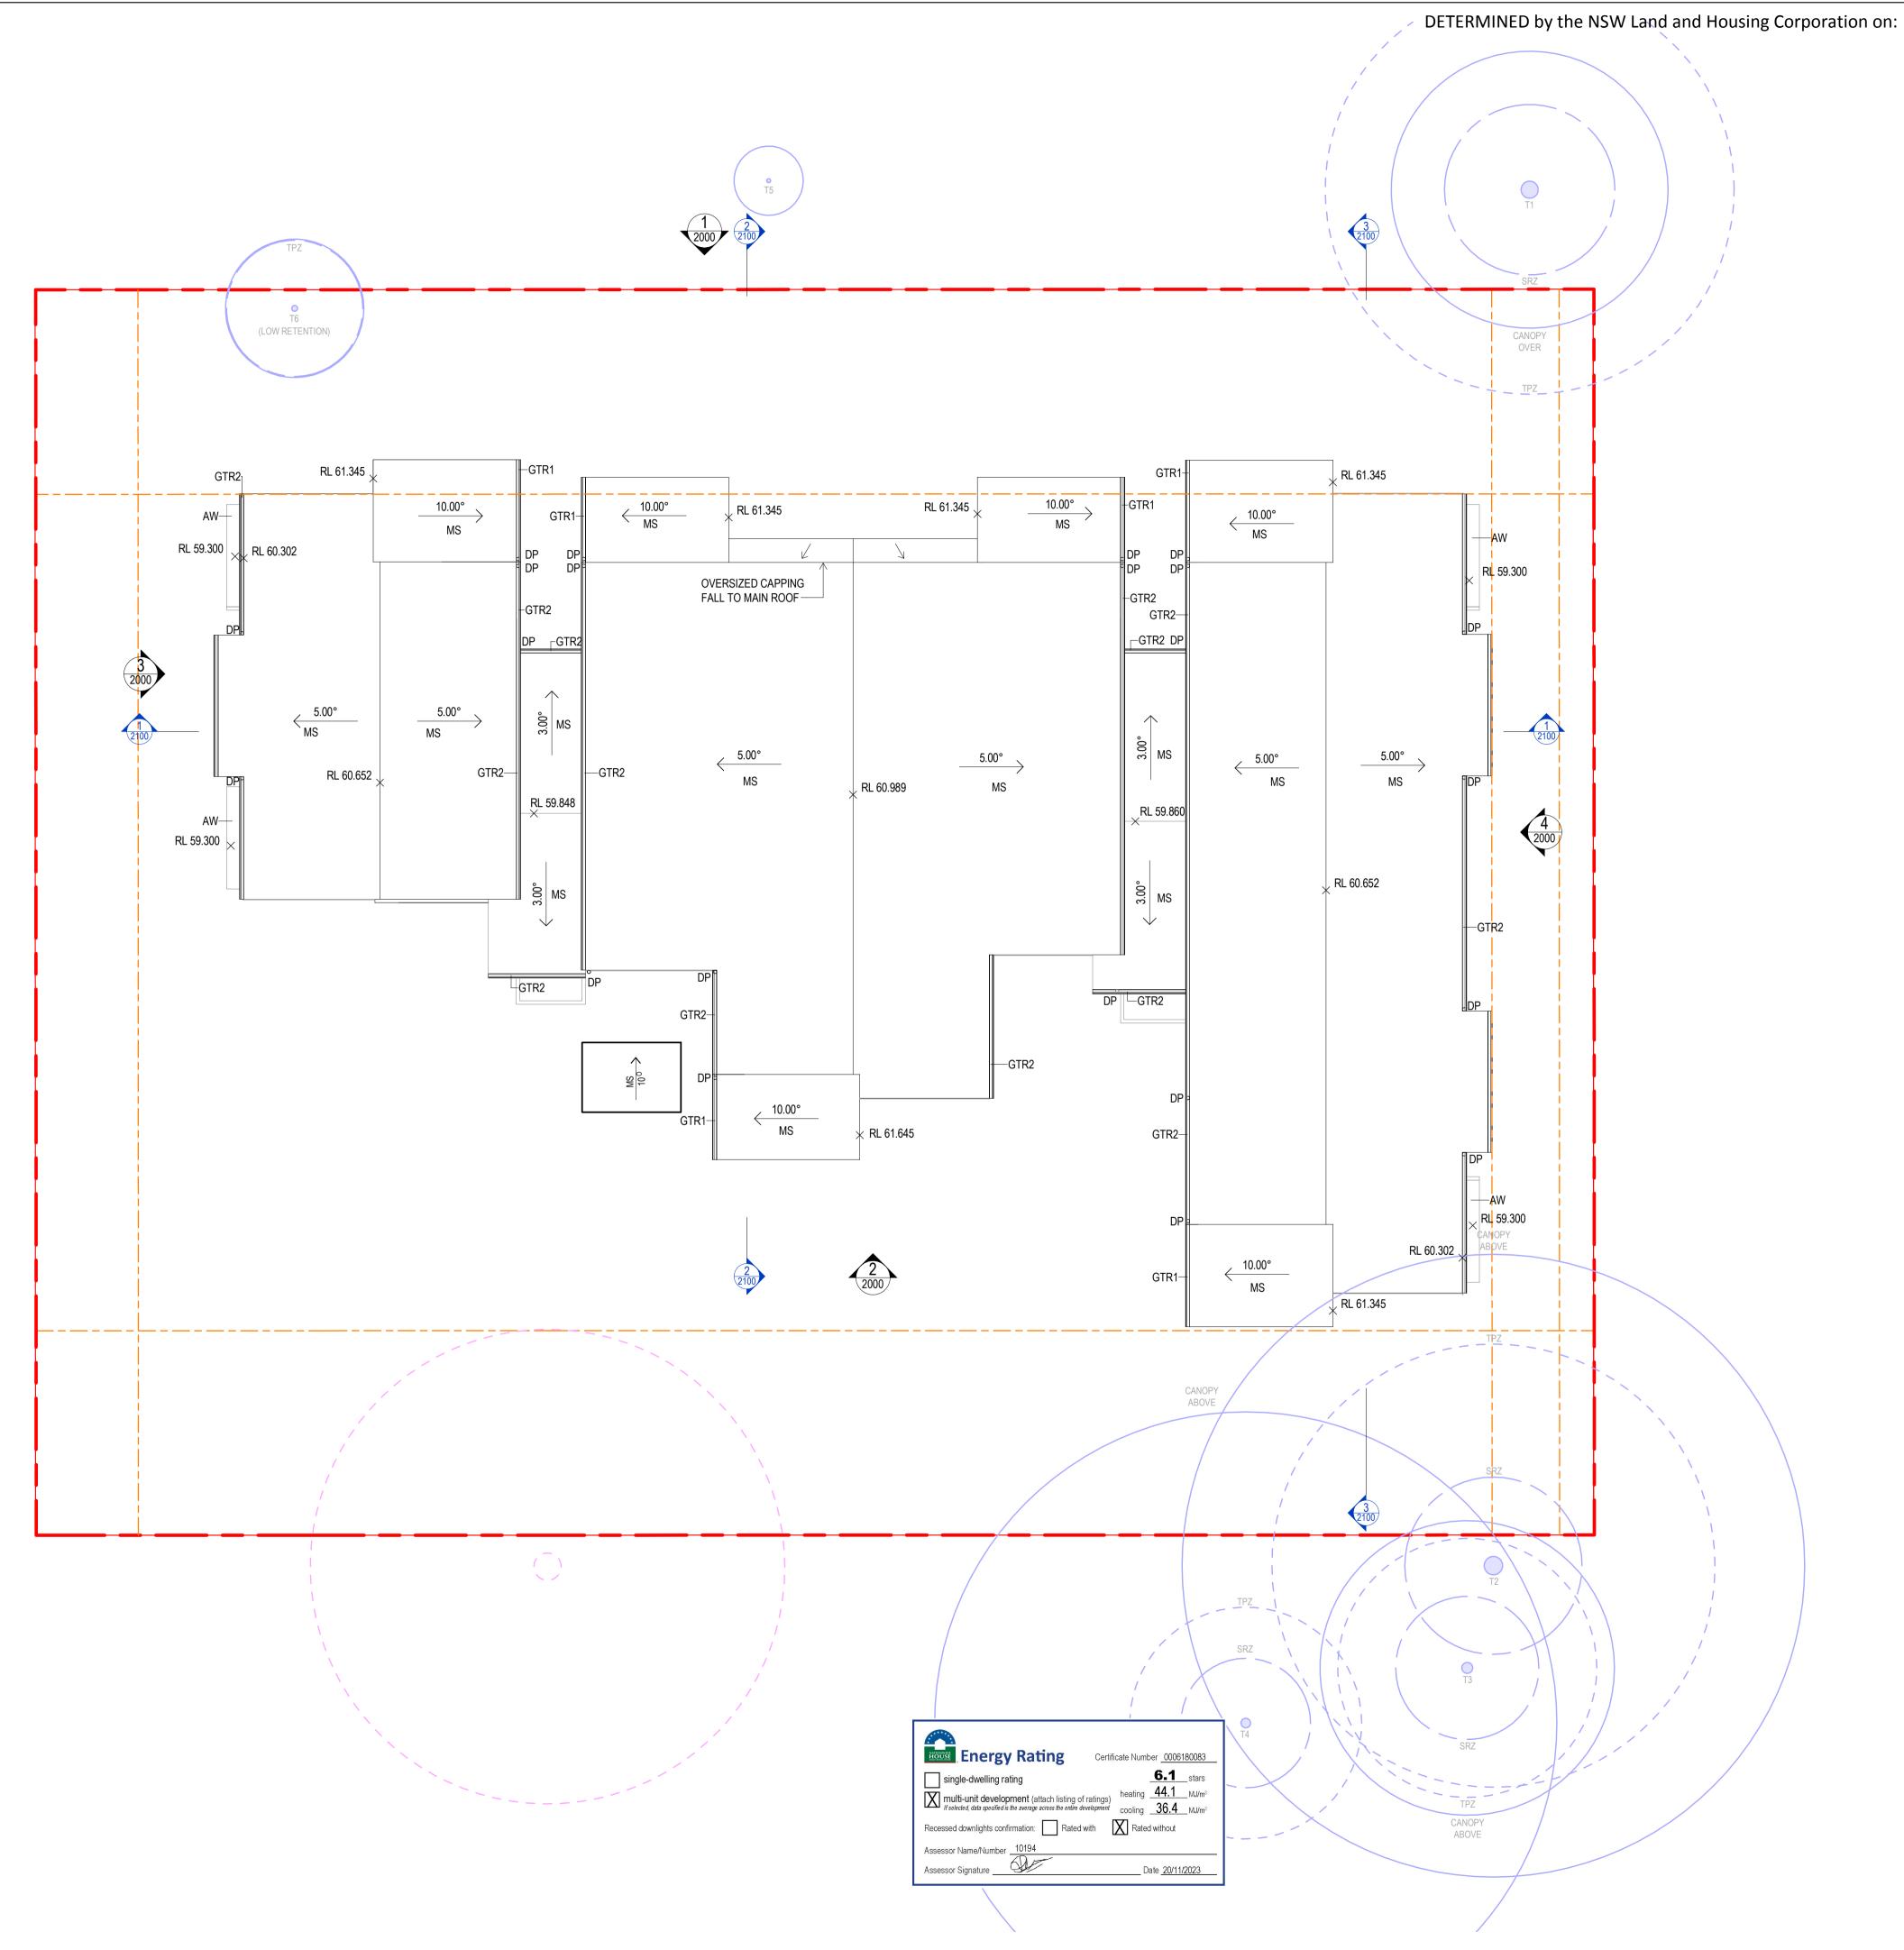AMENDMENTS

REV	DESCRIPTION	AUTH	CHK	DATE
F	DRAFT PART 5	VL	KM	02.11.22
G	DRAFT PART 5	VL	KM	04.11.22
Н	DRAFT PART 5	VL	KM	09.11.22
Ι	PART 5	VL	KM	16.11.22
J	PART 5	BB	MW	31.05.23
K	PART 5	BB	MW	13.06.23
L	PART 5	BB	MW	17.07.23
М	PART 5	BB	MW	12.10.23
Ν	PART 5	BB	MW	16.11.23



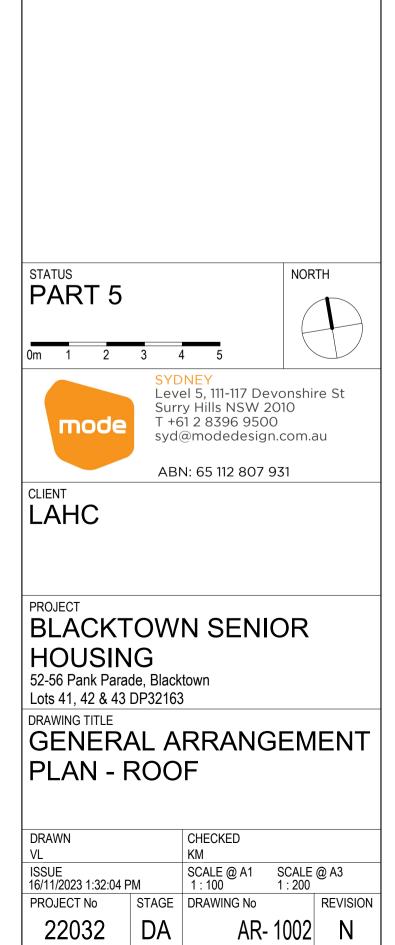

16.11.22

31.05.23

13.06.23

17.07.23



Energy Rating Certificate Number _0006180083_
single-dwelling rating 6.1 stars multi-unit development (attach listing of ratings) heating 44.1 MJ/m² If selected, data specified is the average across the entire development cooling 36.4 MJ/m² Recessed downlights confirmation: Rated with X Rated without
Assessor Name/Number 10194 Assessor Signature Date 20/11/2023

20 December 2023	Pty • Ve • DC • Re	ese designs and y Ltd and canno rify all dimensio) NOT scale off port any discrep rk.	t be reprodu ns on site p these drawi	rior to com ngs.	it writte mence	n permiss ment of wo	ion. ork.
			AME		5		
	REV	DES	CRIPTION		AUTH	CHK	DATE
	Е	STAGE B - SK	ETCH DES	IGN \	/L	KM	10.10.22
	F	DRAFT PART			/L	KM KM	02.11.22 04.11.22
	H	DRAFT PART			/L	KM	09.11.22
	Ι	PART 5			/L	KM	16.11.22
_	J K	PART 5 PART 5			3B 3B	MW MW	13.06.23 17.07.23
_	L	PART 5			BB	MW	12.10.23
	М	PART 5		E	3B	MW	16.11.23
	STAT PA Om	TUS ART 5 1 2 mode	Leve Surr T +6	• 5 NEY el 5, 111-1 y Hills N 1 2 8396 @modeo	SW 2 5 950	2010 0	
		ART 5	SYD Leve Surr T +6 syd@ ABN	NEY el 5, 111-1 y Hills N 1 2 8396 @modeo 1: 65 112	SW 2 5 950 desig 807	2010 0 n.com.a 931	
	PA Om CLIE LA PRO BI HQ 52-5 Lots DRAV	ART 5	SYD Leve Surr T +6 syd@ ABN ABN G COW IG de, Blackt DP32163	NEY el 5, 111-1 y Hills N 1 2 8396 modec 0 1: 65 112 N SE	SW 2 5 950 desig 807	2010 0 n.com.a 931	
	PA Om CLIE LA PRO BI HQ 52-5 Lots DRA SE	ART 5	SYD Leve Surr T +6 syd@ ABN ABN G COW IG de, Blackt DP32163	NEY el 5, 111-1 y Hills N 1 2 8396 modec demod	SW 2 950 lesig 807	2010 0 n.com.a 931	
	PA Om CLIE LA PRO BI HO 52-5 Lots DRA VL	ART 5	SYD Leve Surr T +6 syd@ ABN ABN G COW IG de, Blackt DP32163	NEY el 5, 111-1 y Hills N 1 2 8396 moded 1: 65 112 N SE town	SW 2 950 4esig 807	2010 0 n.com.a 931	au
	PRO Om CLIE LA PRO BI HO 52-5 Lots DRA SE DRA VL ISSU 16/11	ART 5	SYD Leve Surr T +6 syd@ ABN OW IG de, Blackt DP32163 NS	NEY el 5, 111-1 y Hills N 1 2 8396 modec demod	SW 2 950 lesig 807 ENI	2010 0 n.com.a 931	au

		OPERATIO	DIN	IENSION	COMMENT
TYPE	NO.	N	WIDTH	HEIGHT	COMMENTS
	-,				
GROUND LEVE					
D1	01	SW	940	2400	
D1	02	SW	940	2400	
D1	03	SW	940	2400	
D1	04	SW	940	2400	
D2	05	SL	3200	2500	
D2	06	SL	3200	2500	
D2	07	SL	3200	2500	
D2	08	SL	3200	2500	
D2	09	SL	3200	2500	
D2	10	SL	3200	2500	
D3	17	SL	3000	2500	
LEVEL 01					
D2	11	SL	3200	2500	
D2	12	SL	3200	2500	
D2	13	SL	3200	2500	
D2	14	SL	3200	2500	
D2	15	SL	3200	2500	
D2 D2	15	SL	3200	2500	

			WINDOW SC	HEDULE		
		DIN	IENSION			
TYPE	NO.	WIDTH	HEIGHT	SILL HEIGHT	COMN	IENTS
GROUND LEVE		2000	4500	4000		
W1	01	3000	1500	1000		
W2	02	3000	900	1600	T 1 10	
W3	03	2100	700	1800	Translucent Glass	
W2	04	3000	900	1600	Translucent Olean	
W3	06	2100	700	1000	Translucent Glass	
W1	07	3000	1500	1000		
W1	08	3000	1500	1000		
W1	09	3000	1500	1000		
W4	10	2700	900	1600		
W1	11	3000	1500	1000		
W2	12	3000	900	1600	Transluser (Olara	
W3	13	2100	700	1800	Translucent Glass	
W2	14 15	3000	900	1600		
W2		3000	900	1600	Transformet Olares	
W3	16	2100	700	1800	Translucent Glass	
W2	17	3000	900	1600		
W1	18	3000	1500	1000		
W2	19	3000	900	1600		
W2	20	3000	900	1600		
LEVEL 01						
W1	21	3000	1500	1000		
W2	22	3000	900	1600		
W3	23	2100	700	1800	Translucent Glass	
W2	24	3000	900	1600		
W1	25	3000	1500	1000		
W3	26	2100	700	1000		
W1	27	3000	1500	1000		
W1	28	3000	1500	1000		
W1	29	3000	1500	1000		
W4	30	2700	900	1600		
W1	31	3000	1500	1000		
W2	32	3000	900	1600		
W3	33	2100	700	1800	Translucent Glass	
W2	34	3000	900	1600		
W2	35	3000	900	1600		
W3	36	2100	700	1800	Translucent Glass	
W2	37	3000	900	1600		
W1	38	3000	1500	1000		
W2	39	3000	900	1600		
W2	40	3000	900	1600		
					TRANSCOM	
TYPE	NO.	WIDTH	HEIGHT	SILL HEIGHT	TRANSOM HEIGHT	Comments
W5	42	2330	2900	0	1000	OPERABLE WITH 125MM RESTRICTE
W5	44	2030	2900	0	1000	OPERABLE WITH 125MM RESTRICTE
W5	45	2330	2900	0	1000	OPERABLE WITH 125MM RESTRICTE
W5	47	2180	2900	0	1000	OPERABLE WITH 125MM RESTRICTE

DETERMINED by the NSW Land and Housing Corporation on:

Energy Rating Certificate Number 0006180083
single-dwelling rating <u>6.1</u> stars
multi-unit development (attach listing of ratings) If selected, data specified is the average across the entire development cooling <u>44.1</u> MJ/m ² cooling <u>36.4</u> MJ/m ²
Recessed downlights confirmation: Rated with X Rated without
Assessor Name/Number 10194
Assessor Signature Date 20/11/2023

n: flede . 20 December 2023

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EV	AMENDME			1
E	DESCRIPTION STAGE B - SKETCH DESIGN	AUTH VL	CHK KM	DATE 10.10.22
F	DRAFT PART 5	VL	KM	02.11.22
G	DRAFT PART 5	VL	KM	04.11.22
H	DRAFT PART 5	VL	KM	09.11.22
 J	PART 5 PART 5	VL BB	KM MW	16.11.22
J K	PART 5	BB	MW	17.07.23
L	PART 5	BB	MW	12.10.23
М	PART 5	BB	MW	16.11.23
DC HA WI CC RE AN VI AL	OR NOTES (AU) OOR SCHEDULE TO BE READ IN ARDWARE SCHEDULE. HERE REQUIRED, SEALS ARE T OORDINATE CLOSERS AND LAT EFER TO GA PLANS AND ELEVA ND SLIDING DIRECTION SUAL INDICATORS ON GLAZING L GLASS SELECTED AND INSTA FETY GLASS WHERE REQUIRE	O BE COM CHES TO TIONS FC TO COM	NTINUOUS SUIT. DR DOOR PLY WITH	s. Handing
	RILLES TO MECHANICAL ENGIN ROP BOLTS TO ALL NON-LOCKI DORS UNLESS NOTED OTHERW BI-FOLDING CAVITY SLIDING FACE SLIDING GRILLE (COLLAPSING) HINGED (SIDE) OVERHEAD (SECTIONAL) MULTI-FOLDING (CONCERTINA) PIVOT ROLL-UP (SHUTTER/ GRILLE)	NG LEAFS		
- V K	SLIDING STACKING TILT PANEL (OVERHEAD) WALL, OPERABLE OPENING ONLY			
MF FF SOF INI AN GL PC IAF ENSS PSS PTS	ROLLER SHUTTER SMOKE DOOR FIRE DOOR METAL FRAME TIMBER FRAME ALUMINIUM FRAME ROLLER SHUTTER FRAME SECTIONAL OVERHEAD FRA SECTIONAL OVERHEAD FRA SHES ANODISED ALUMINIUM - CLE FRAMELESS GLASS PAINT POWDERCOAT COMMARE SETS ENTRY SET EXIT SET ENTRY SET EXIT SET PASSAGE SET PASSAGE SET PATIO SET MELEVATIONS VISION PANEL	AME		
	TUS ART 5 NOTE SYDNEY Level 5, 1 Surry Hill T +61 2 83 syd@mod	s NSW 396 950	2010)0	
LIE _/	ABN: 65	112 807	931	
	NT	SEN		



PANK PARADE PERSPECTIVE

Energy Rating Certificate Number _0006180083_
single-dwelling rating <u>6.1</u> stars
If selected, data specified is the average across the entire development cooling 36.4 MJ/m ²
Recessed downlights confirmation: Rated with Rated without
Assessor Name/Number

Elech.


20 December 2023

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AMENDMENTS

REV	DESCRIPTION	AUTH	CHK	DATE
Α	DRAFT PART 5	VL	KM	04.11.22
В	DRAFT PART 5	VL	KM	09.11.22
С	PART 5	VL	KM	16.11.22
D	PART 5	BB	MW	13.06.23
E	PART 5	BB	MW	17.07.23
F	PART 5	BB	MW	12.10.23
G	PART 5	BB	MW	16.11.23
	•			



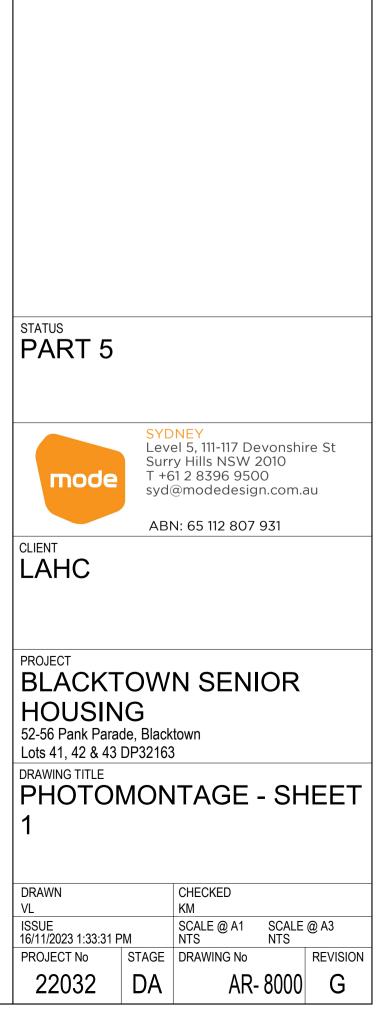


PANK PARADE PERSPECTIVE


Energy Rating Certificate Number 0006180083
single-dwelling rating 6.1 stars Multi-unit development (attach listing of ratings) heating 44.1 MJ/m² If selected, data specified is the average across the entire development 36.4 MJ/m²
Recessed downlights confirmation: Rated with Rated without Assessor Name/Number 10194
Assessor Signature Date 20/11/2023

20 December 2023

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AMENDMENTS							
REV	DESCRIPTION	AUTH	CHK	DATE			
Α	DRAFT PART 5	VL	KM	04.11.22			
В	DRAFT PART 5	VL	KM	09.11.22			
С	PART 5	VL	KM	16.11.22			
D	PART 5	BB	MW	13.06.23			
Е	PART 5	BB	MW	17.07.23			
F	PART 5	BB	MW	12.10.23			
G	PART 5	BB	MW	16.11.23			



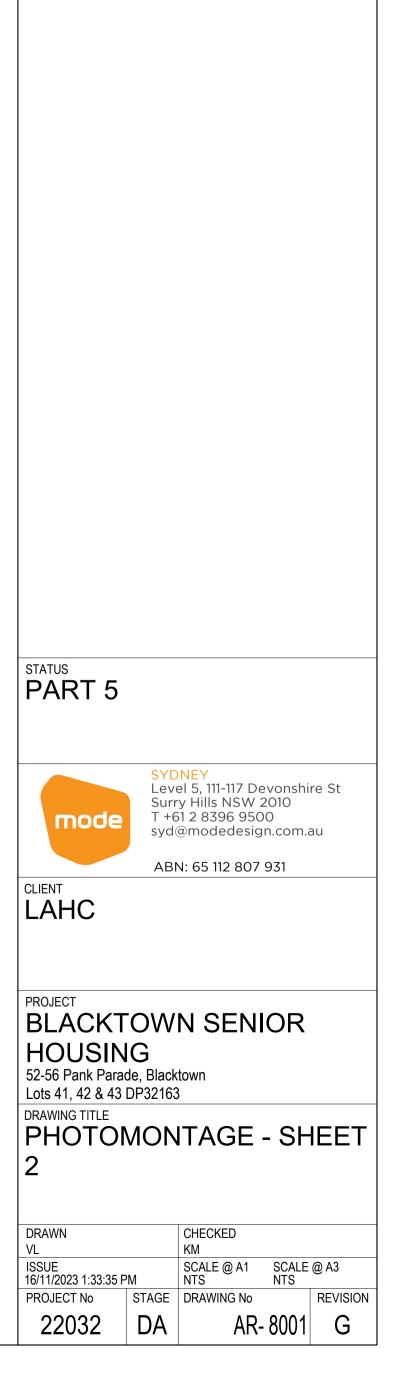
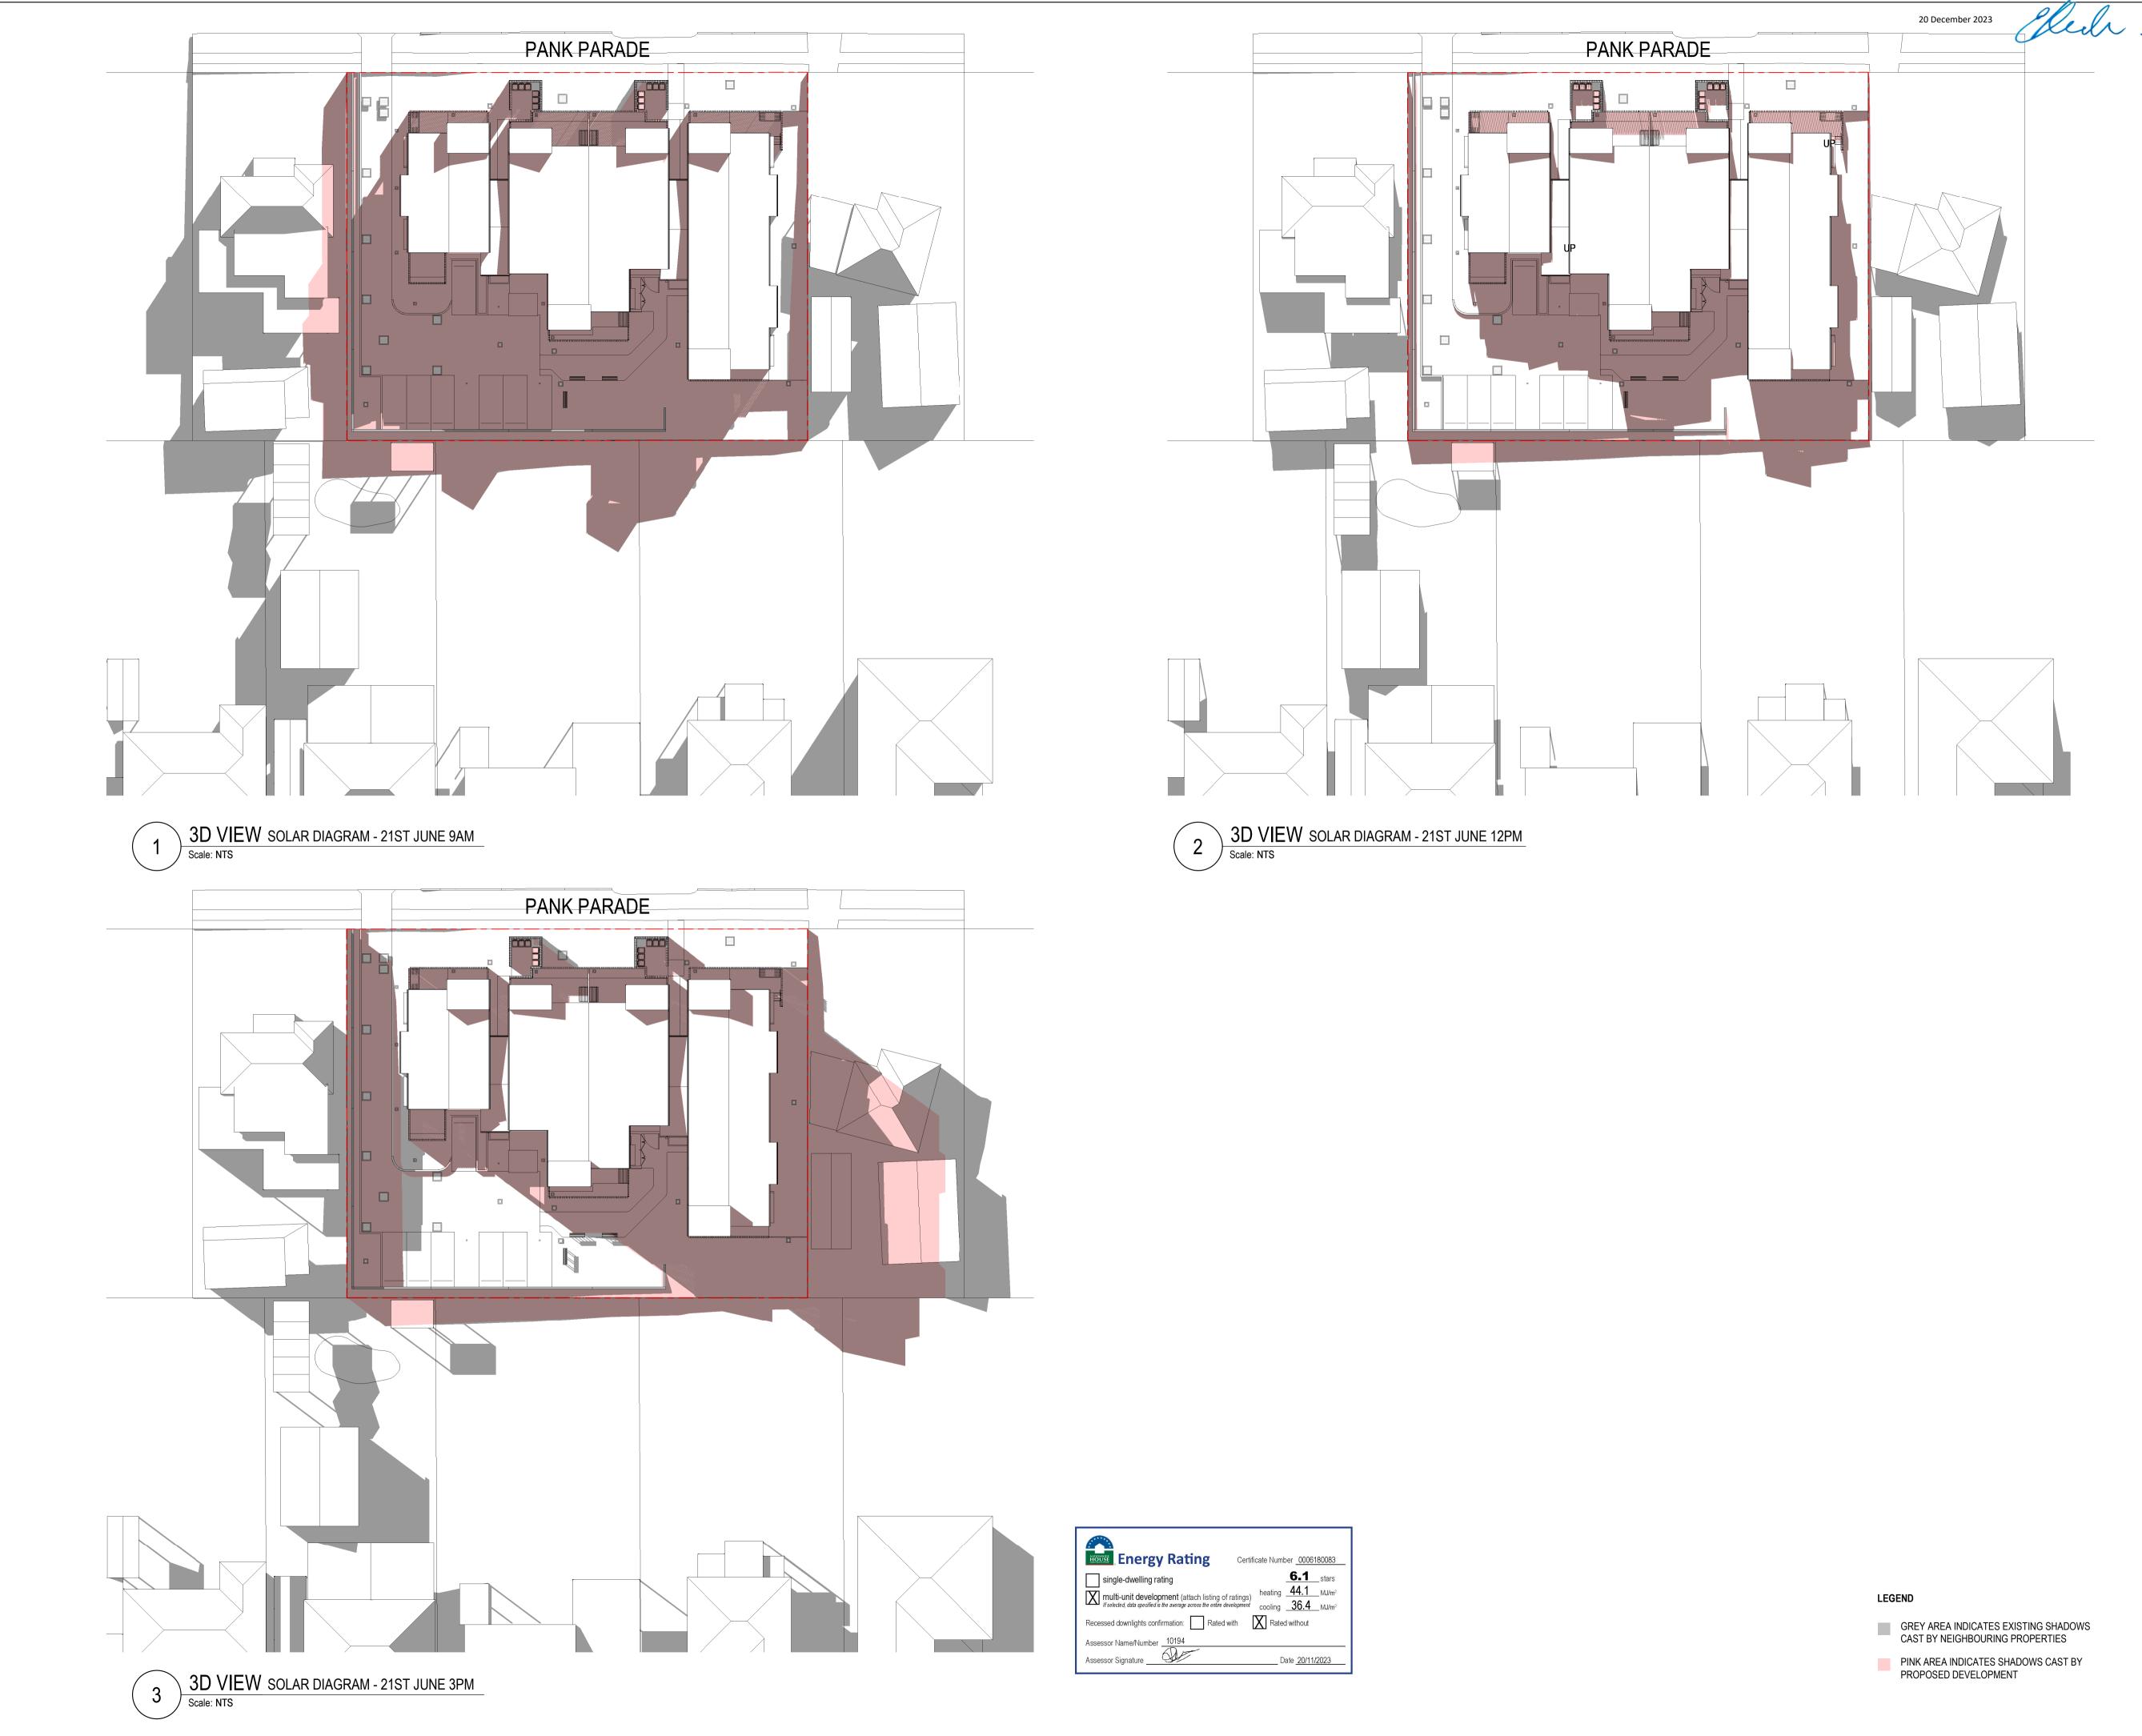
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AMENDMENTS


REV	DESCRIPTION	AUTH	CHK	DATE
F	DRAFT PART 5	VL	KM	02.11.22
G	DRAFT PART 5	VL	KM	04.11.22
Н	DRAFT PART 5	VL	KM	09.11.22
I	PART 5	VL	KM	16.11.22
J	PART 5	BB	MW	31.05.23
Κ	PART 5	BB	MW	13.06.23
L	PART 5	BB	MW	17.07.23
М	PART 5	BB	MW	12.10.23
Ν	PART 5	BB	MW	16.11.23


STATUS			NOR	ТН
PART 5				
	Leve	NEY el 5, 111-117 De	vonshi	re St
mode	Surr T +6	y Hills NSW 2 61 2 8396 9500 @modedesigr	010 C	
		N: 65 112 807 9		
BLACKT		IN SEINI	UR	
52-56 Pank Para Lots 41, 42 & 43	de, Black			
DRAWING TITLE				
SOLAR	ANA	LYSIS		
DRAWN		CHECKED		
1				
VL		KM	SCALE	@ A3
VL ISSUE 16/11/2023 1:33:46 F PROJECT №	M		SCALE NTS	@ A3 REVISION



3D VIEW VIEW FROM SUN ANGLE - 11AM 3 Scale: NTS

	SOLAR ACCESS - GROUND FLOOR											
UNIT NO.	UNIT 01		1 UNIT 02		UNI	Т 03	3 UNIT 04		UNI	T 05	UNI	T 06
	LIVING	POS	LIVING	POS	LIVING	POS	LIVING	POS	LIVING	POS	LIVING	POS
9AM - 10AM												
10AM - 11AM												
11AM - 12PM												
12PM - 1PM												
1PM - 2PM												
2PM - 3PM												

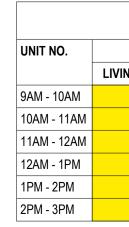


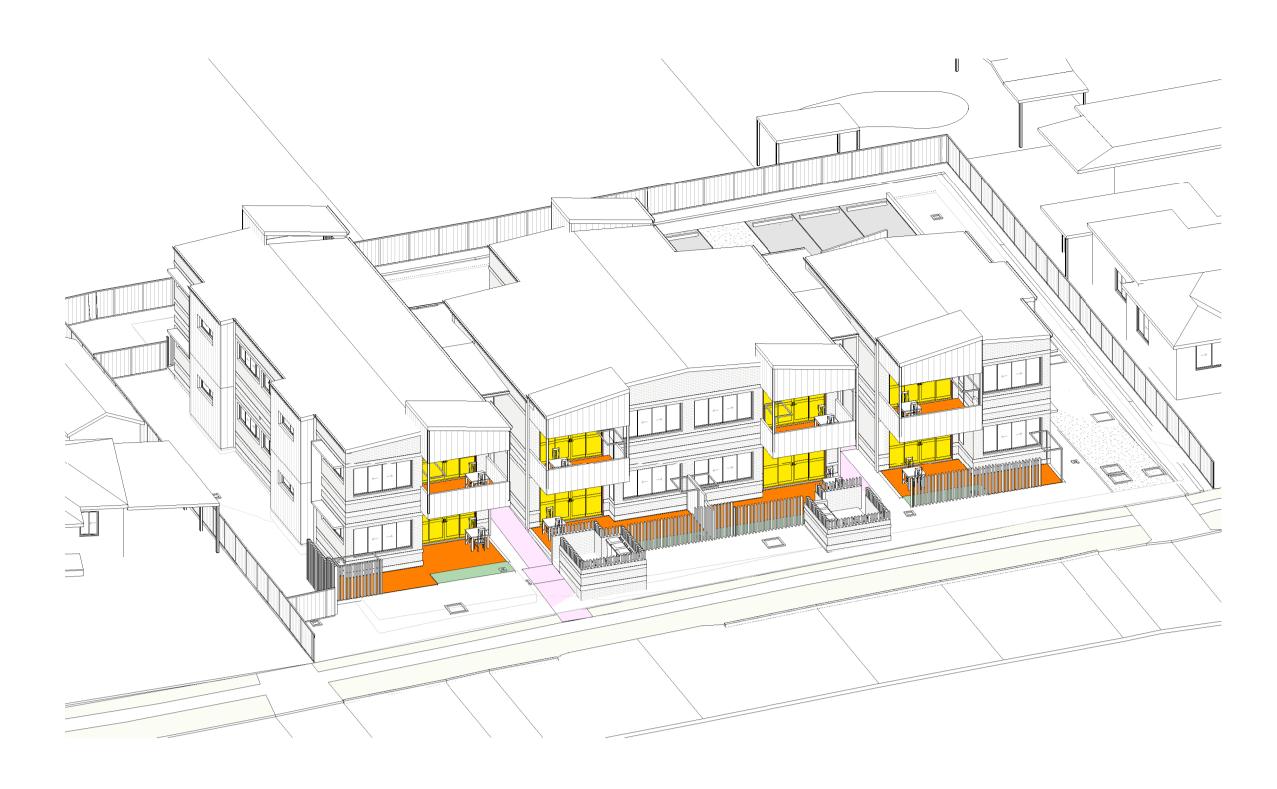





SOLAR ACCESS - FIRST FLOOR											
UNIT 07 UNIT 08 UNIT 09 UNIT 10 UNIT 11 UNIT 12								Г 12			
ING	POS	LIVING	POS								

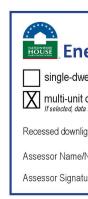

20 December 2023

Heit

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nergy Rating Certifi	cate Number <u>0006180083</u>
welling rating	6.1 _stars
it development (attach listing of ratings) lata specified is the average across the entire development	heating <u>44.1</u> MJ/m ² cooling <u>36.4</u> MJ/m ²
nlights confirmation: Rated with	X Rated without
e/Number	;
ature	Date <u>20/11/2023</u>

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AMENDMENTS

REV	DESCRIPTION	AUTH	CHK	DATE
Α	STAGE B - SKETCH DESIGN	VL	KM	10.10.22
В	DRAFT PART 5	VL	KM	02.11.22
С	DRAFT PART 5	VL	KM	04.11.22
D	DRAFT PART 5	VL	KM	09.11.22
E	PART 5	VL	KM	16.11.22
F	PART 5	BB	MW	13.06.23
G	PART 5	BB	MW	17.07.23
Н	PART 5	BB	MW	12.10.23
I	PART 5	BB	MW	16.11.23

STATUS PART 5




SYDNEY Level 5, 111-117 Devonshire St Surry Hills NSW 2010 T +61 2 8396 9500 syd@modedesign.com.au

ABN: 65 112 807 931

PROJECT BLACKTOWN SENIOR HOUSING 52-56 Pank Parade, Blacktown Lots 41, 42 & 43 DP32163


DRAWING TITLE SOLAR STUDY - SHEET 1

DRAWN		CHECKED		
VL		KM		
ISSUE 16/11/2023 1:34:19 PM		SCALE @ A1 NTS	SCALE NTS	@ A3
PROJECT No	STAGE	DRAWING No		REVISION
22032	DA	AR-	I	

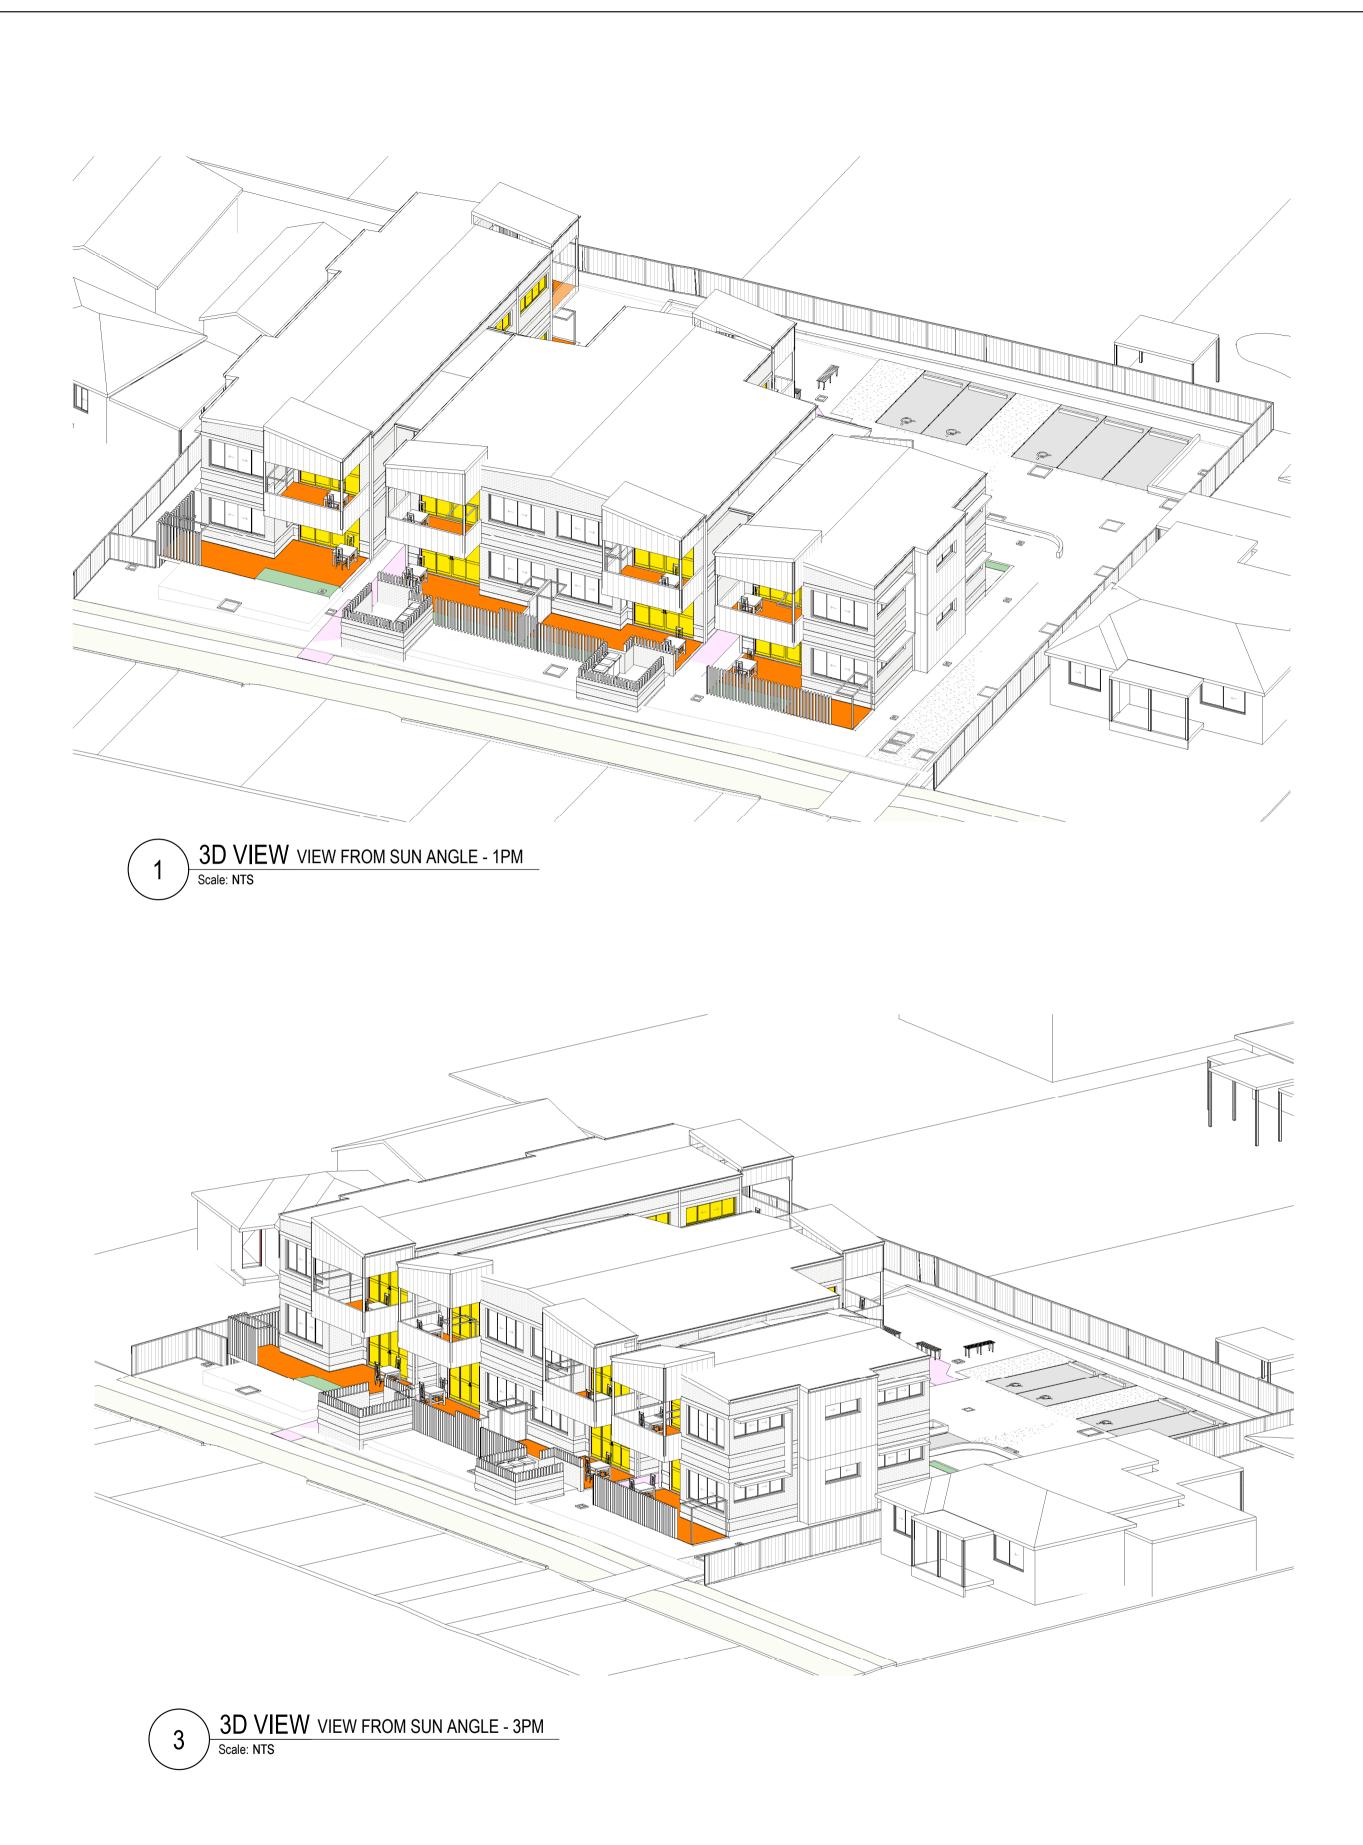

	SOLAR ACCESS - GROUND FLOOR											
UNIT NO. UNIT 01 LIVING POS		UNIT 02 UNIT 03		UNIT 04		UNIT 05		UNIT 06				
		POS	LIVING	POS	LIVING	POS	LIVING	POS	LIVING	POS	LIVING	POS
9AM - 10AM												
10AM - 11AM												
11AM - 12PM												
12PM - 1PM												
1PM - 2PM												
2PM - 3PM												

	SOLAR ACCESS - FIRST FLOOR											
UNIT NO.	UNIT 07		UNIT 08		UNIT 09		UNIT 10	UNIT 11		UNIT 12		
-	LIVING	POS	LIVING	POS	LIVING	POS	LIVING	POS	LIVING	POS	LIVING	POS
9AM - 10AM												
10AM - 11AM												
11AM - 12AM												
12AM - 1PM												
1PM - 2PM												
2PM - 3PM												

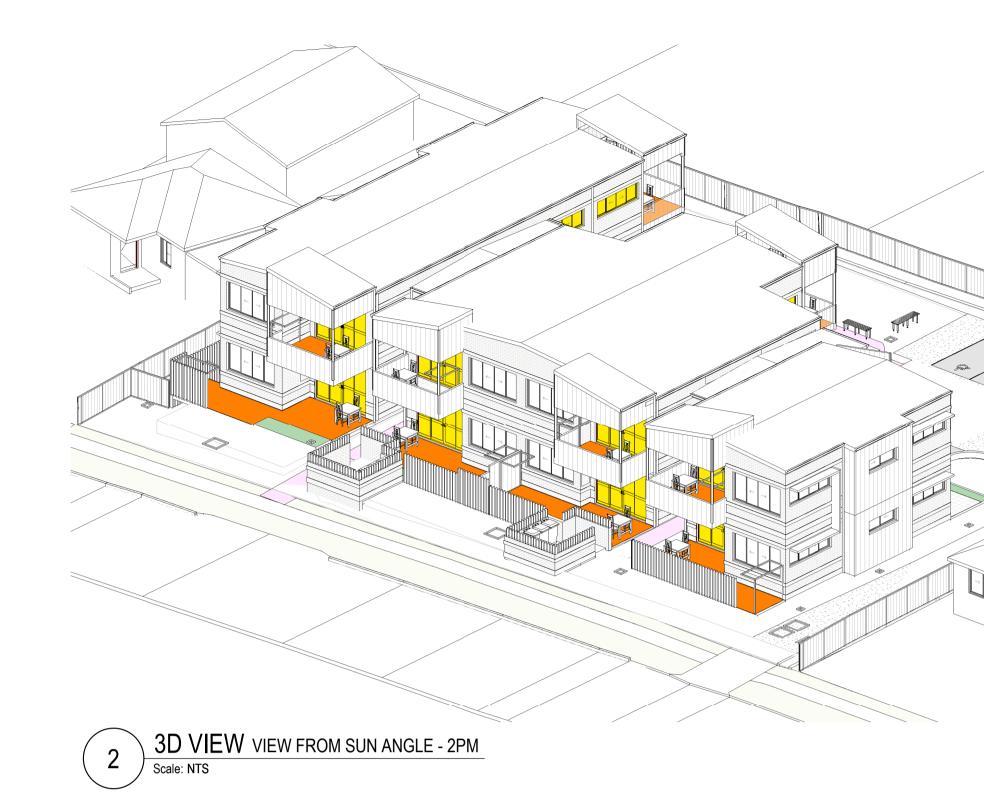



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A STAGE B - SKETCH DESIGN VL KM 10.10 B DRAFT PART 5 VL KM 02.11 C DRAFT PART 5 VL KM 04.11 D DRAFT PART 5 VL KM 09.11 E PART 5 VL KM 16.11 F PART 5 BB MW 13.06 G PART 5 BB MW 17.07 H PART 5 BB MW 12.10	REV DESCRIPTION AUTH CHK DATE A STAGE B - SKETCH DESIGN VL KM 10.10.2 B DRAFT PART 5 VL KM 02.11.2 C DRAFT PART 5 VL KM 04.11.2 D DRAFT PART 5 VL KM 04.11.2 E PART 5 VL KM 10.10.2 F PART 5 VL KM 04.11.2 G PART 5 VL KM 10.10.2 H PART 5 BB MW 13.06.2						
A STAGE B - SKETCH DESIGN VL KM 10.10 B DRAFT PART 5 VL KM 02.11 C DRAFT PART 5 VL KM 04.11 D DRAFT PART 5 VL KM 09.11 E PART 5 VL KM 16.11 F PART 5 BB MW 13.06 G PART 5 BB MW 17.07 H PART 5 BB MW 12.10	A STAGE B - SKETCH DESIGN VL KM 10.10.2 B DRAFT PART 5 VL KM 02.11.2 C DRAFT PART 5 VL KM 04.11.2 D DRAFT PART 5 VL KM 04.11.2 E PART 5 VL KM 09.11.2 F PART 5 VL KM 16.11.2 F PART 5 BB MW 13.06.2 G PART 5 BB MW 17.07.2 H PART 5 BB MW 12.10.2		AMENDMENTS				
B DRAFT PART 5 VL KM 02.11 C DRAFT PART 5 VL KM 04.11 D DRAFT PART 5 VL KM 09.11 E PART 5 VL KM 16.11 F PART 5 BB MW 13.06 G PART 5 BB MW 17.07 H PART 5 BB MW 12.10	B DRAFT PART 5 VL KM 02.11.2 C DRAFT PART 5 VL KM 04.11.2 D DRAFT PART 5 VL KM 09.11.2 E PART 5 VL KM 16.11.2 F PART 5 VL KM 16.11.2 G PART 5 BB MW 13.06.2 G PART 5 BB MW 17.07.2 H PART 5 BB MW 12.10.2	REV	DESCRIPTION	AUTH	CHK	DATE	
C DRAFT PART 5 VL KM 04.11 D DRAFT PART 5 VL KM 09.11 E PART 5 VL KM 16.11 F PART 5 BB MW 13.06 G PART 5 BB MW 17.07 H PART 5 BB MW 12.10	C DRAFT PART 5 VL KM 04.11.2 D DRAFT PART 5 VL KM 09.11.2 E PART 5 VL KM 16.11.2 F PART 5 BB MW 13.06.2 G PART 5 BB MW 17.07.2 H PART 5 BB MW 12.10.2	Α	STAGE B - SKETCH DESIGN	VL	KM	10.10.22	
D DRAFT PART 5 VL KM 09.11 E PART 5 VL KM 16.11 F PART 5 BB MW 13.06 G PART 5 BB MW 17.07 H PART 5 BB MW 12.10	D DRAFT PART 5 VL KM 09.11.2 E PART 5 VL KM 16.11.2 F PART 5 BB MW 13.06.2 G PART 5 BB MW 17.07.2 H PART 5 BB MW 12.10.2	В	DRAFT PART 5	VL	KM	02.11.22	
E PART 5 VL KM 16.11 F PART 5 BB MW 13.06 G PART 5 BB MW 17.07 H PART 5 BB MW 12.10	E PART 5 VL KM 16.11.2 F PART 5 BB MW 13.06.2 G PART 5 BB MW 17.07.2 H PART 5 BB MW 12.10.2	С	DRAFT PART 5	VL	KM	04.11.22	
F PART 5 BB MW 13.06 G PART 5 BB MW 17.07 H PART 5 BB MW 12.10	F PART 5 BB MW 13.06.2 G PART 5 BB MW 17.07.2 H PART 5 BB MW 12.10.2	D	DRAFT PART 5	VL	KM	09.11.22	
G PART 5 BB MW 17.07 H PART 5 BB MW 12.10	G PART 5 BB MW 17.07.2 H PART 5 BB MW 12.10.2	Е	PART 5	VL	KM	16.11.22	
H PART 5 BB MW 12.10	H PART 5 BB MW 12.10.2	F	PART 5	BB	MW	13.06.23	
		G	PART 5	BB	MW	17.07.23	
I PART 5 BB MW 16.11	I PART 5 BB MW 16.11.2	Н	PART 5	BB	MW	12.10.23	
			PART 5	BB	MW	16.11.23	

STATUS PART 5



SYDNEY Level 5, 111-117 Devonshire St Surry Hills NSW 2010 T +61 2 8396 9500 syd@modedesign.com.au

ABN: 65 112 807 931

PROJECT BLACKTOWN SENIOR

DRAWING TITLE SOLAR STUDY - SHEET 2

CHECKED KM

STAGE DRAWING No

SCALE @ A1 SCALE @ A3 NTS NTS

AR- 8201 I

REVISION

HOUSING 52-56 Pank Parade, Blacktown Lots 41, 42 & 43 DP32163

CLIENT LAHC


DRAWN

ISSUE 16/11/2023 1:35:38 PM

22032 DA

PROJECT No

Date 20/11/2023

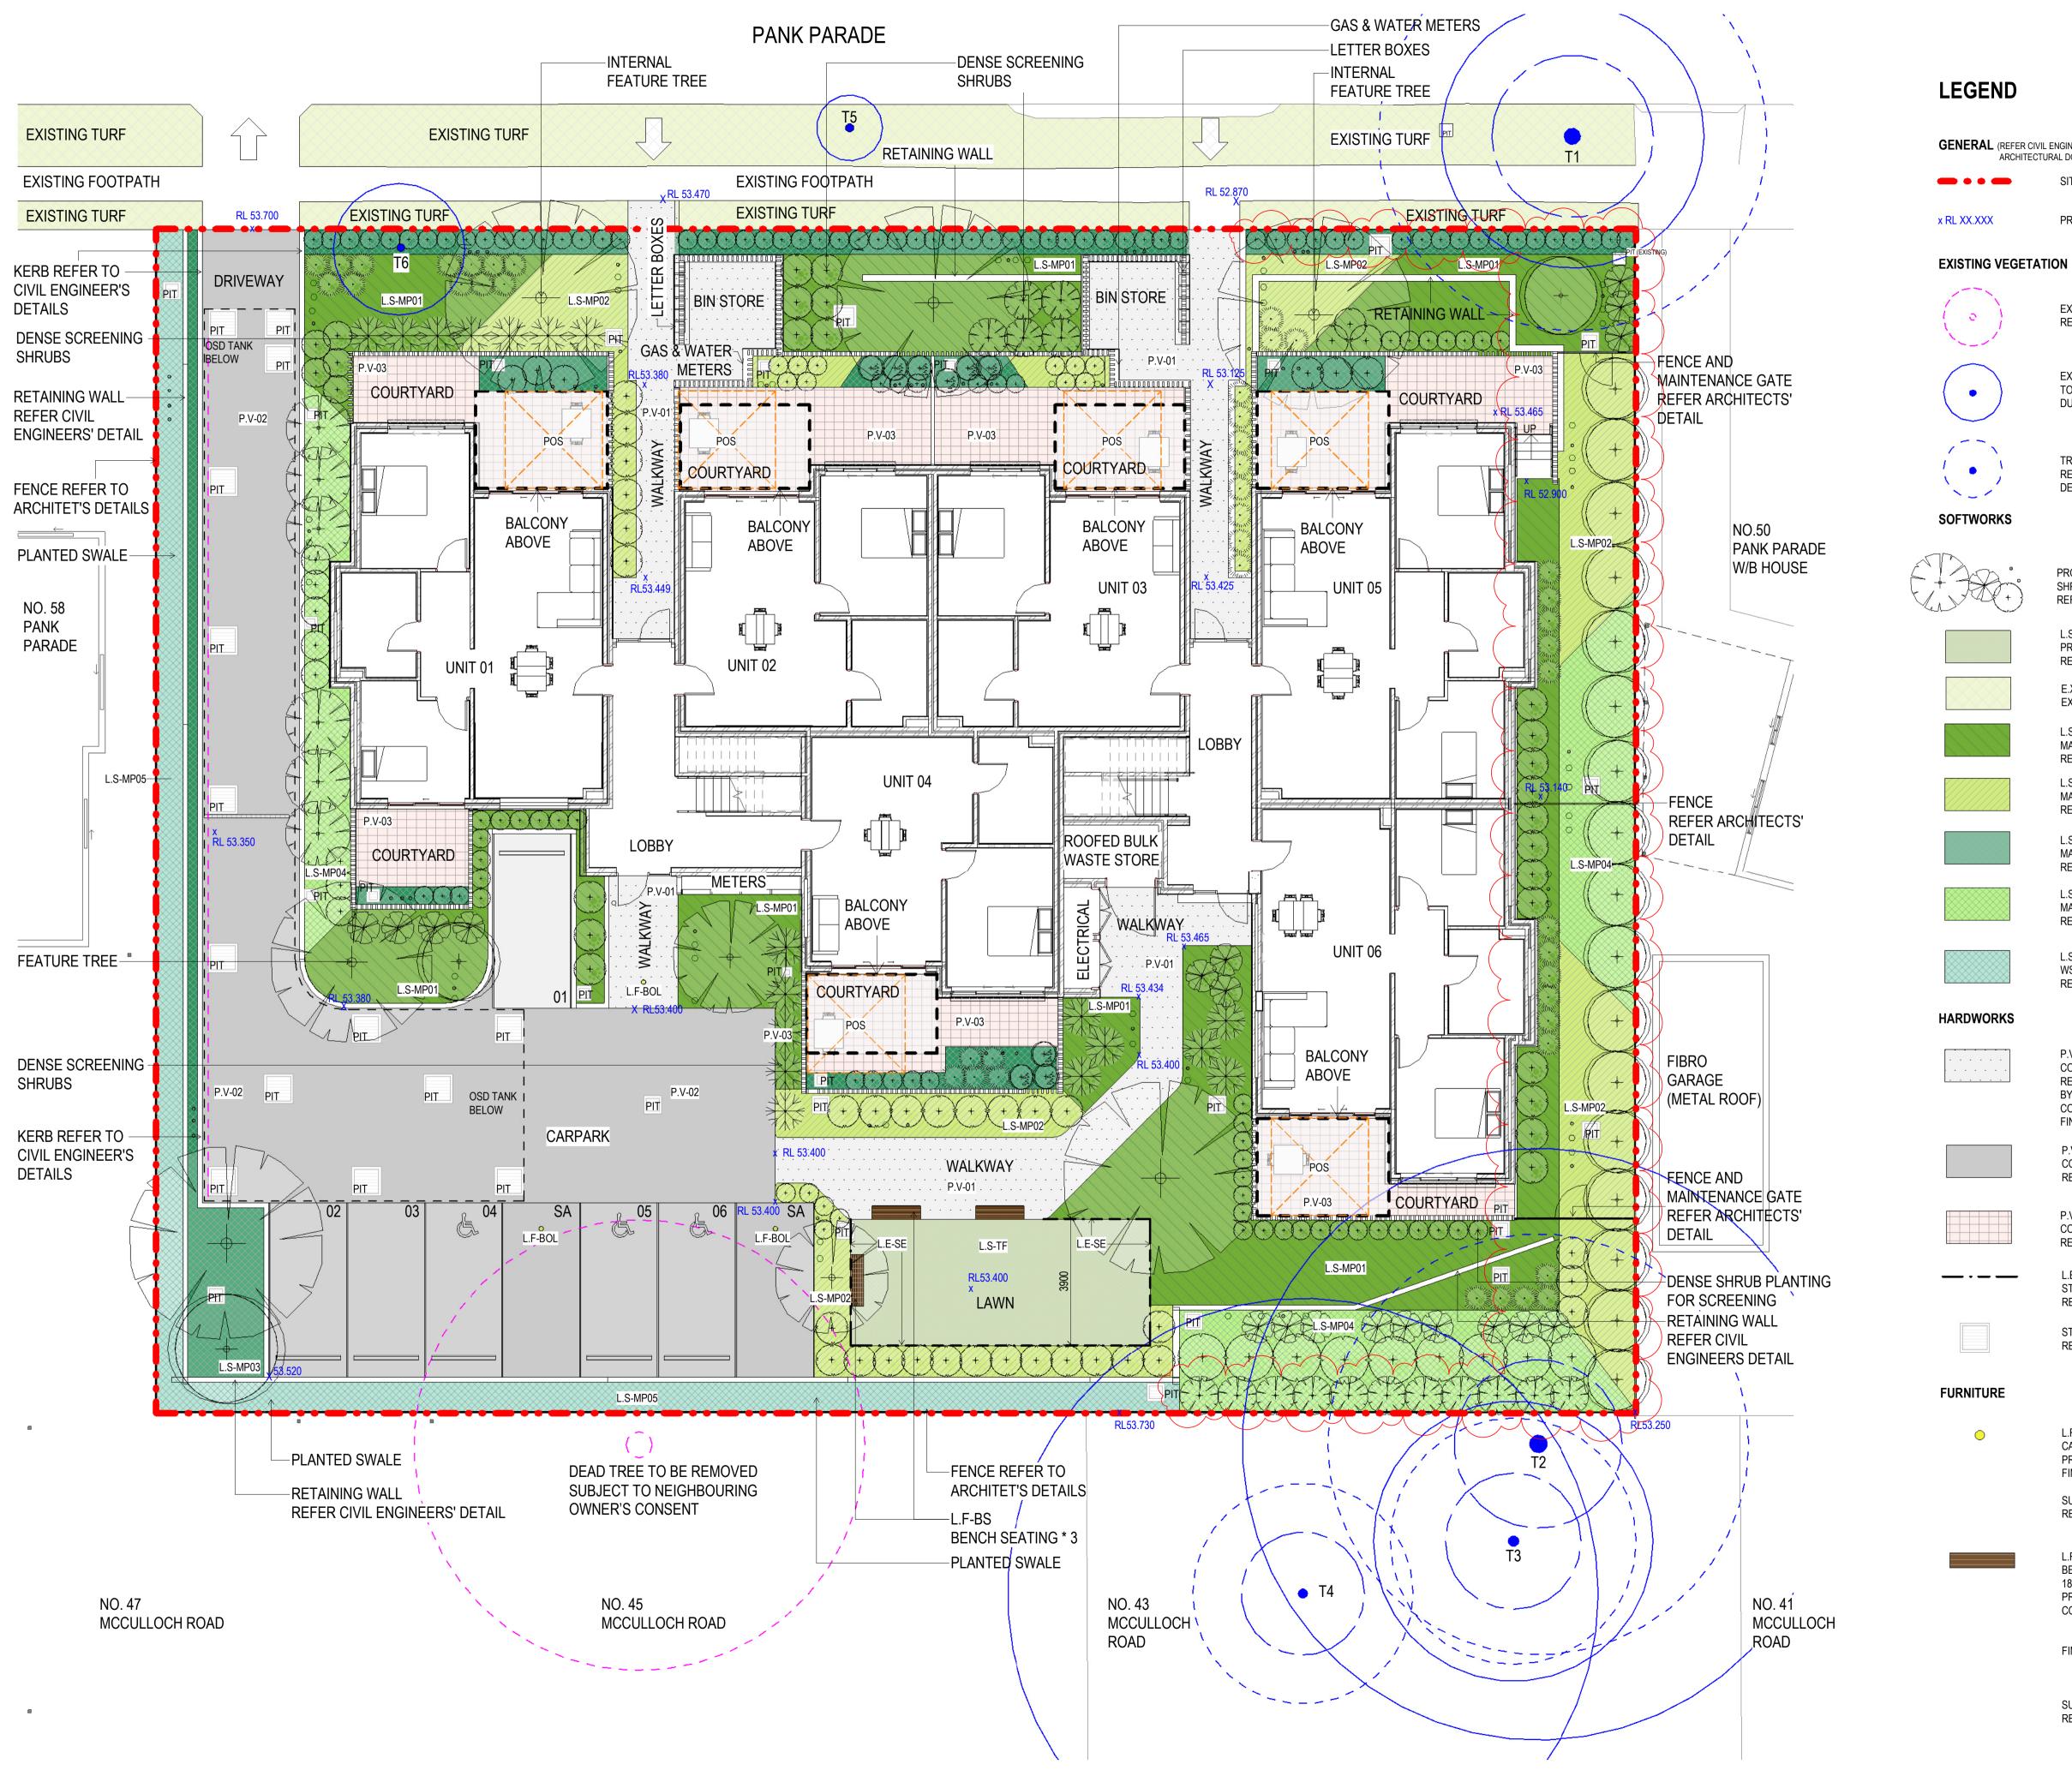

ng Corporation on:	en 1
20 December 2023	all

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Verify all dimensions on site prior to commencement of work. DO NOT scale off these drawings.

Report any discrepancies to the architect before carrying out any

work.

GENERAL (REFER CIVIL ENGINEER & ARCHITECTURAL DOCUMENTATION)

SITE BOUNDARY


PROPOSED LEVELS

EXISTING TREES TO BE RETAINED & PROTECTED

EXISTING TREES TO BE REMOVED

REFER ARBORIST REPORT

DURING CONSTRUCTION

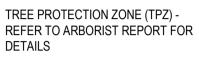

PROPOSED FEATURE TREES/ SHRUBS/GROUNDCOVERS REFER PLANTING PLANS AND SCHEDULE

L.S-TF PROPOSED TURF/ LAWN AREA REFER TO DETAIL 4 | LD-5001

E.X-TF EXISTING TURF

L.S-MP01 MASS PLANTING MIX 1 REFER TO DETAIL 3 | LD-5001

L.S-MP02 MASS PLANTING MIX 2 REFER TO DETAIL 3 | LD-5001

L.S-MP03 MASS PLANTING MIX 3 REFER TO DETAIL 3 | LD-5001

L.S-MP04 MASS PLANTING MIX 4 REFER TO DETAIL 3 | LD-5001

L.S-MP05 WSUD MASS PLANTING REFER TO DETAIL 1,2 | LD-5002

COLOURED CONCRETE

COLOUR: CCS PEWTER

CONCRETE PAVEMENT

REFER CIVIL ENGINEER'S DETAIL

REFER TO DETAIL 6 | LD- 5002

BY CONCRETE COLOUR SYSTEMS TBC

P.V-01

FINISH: TBC

P.V-02

P.V-03

COURTYARD PAVING **REFER ARCHITECT'S DETAIL** L.E-SE


STEEL EDGING REFER DETAIL 7 | LD- 5001 STORMWATER PITS

REFER TO CIVIL ENGINEER'S DETAILS

L.F-BOL CARPARK BOLLARD - REMOVABLE PRODUCT CODE: HIG150R B 7.11 FINISH: ELECTROSTATICALLY POWDER COATED IN INDUSTRIAL YELLOW SUPPLIER: LEDA SECURITY REFER DETAIL 1 | LD- 5003

L.F-BS

BENCH SEATING WITH BACKREST 1800mmW x 530mmD x 820mmH PRODUCT CODE: VERG.S.18.HW.U COLOURS: TBA HARDWOORD: OILED SPOTTED GUM OR CLEAR OILED MIXED RED FINISH: FRAME & POST: POWDER COATED TO PALLADIUM SILVER POWDER FIXING: FIXED SURFACE OR CORE HOLE SLAT: HARDWOOD SUPPLIER: BOTTON + GARDINER REFER DETAIL 2,3 | LD- 5003

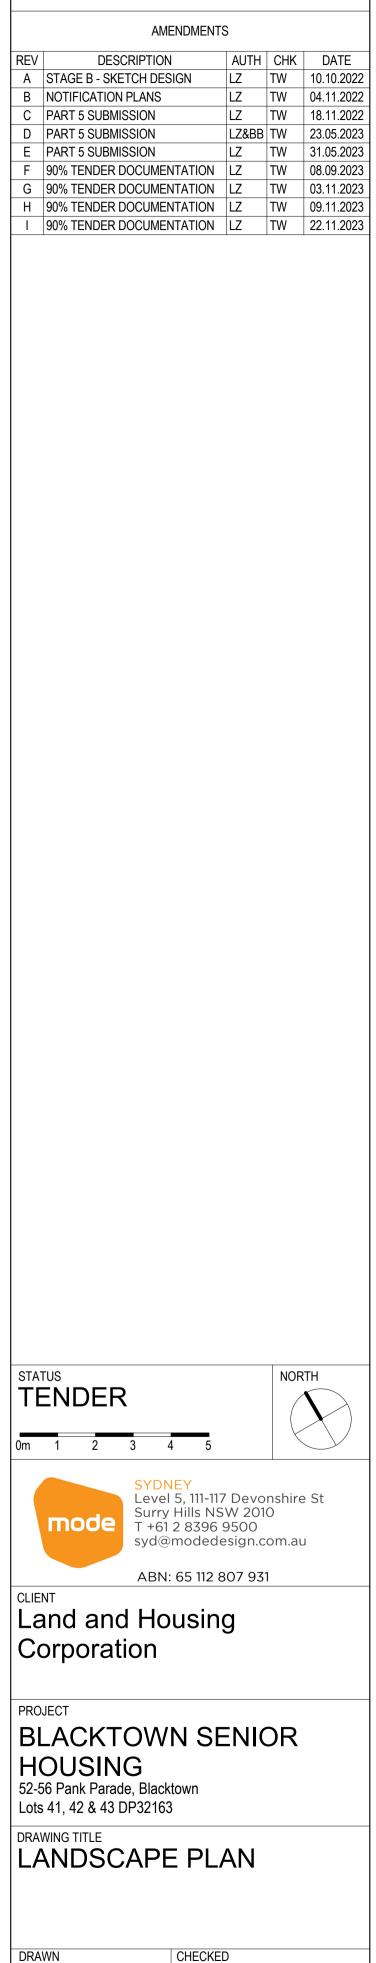

TW

1:100

STAGE DRAWING No

TD

SCALE @ A1

REVISION


LD- 1000

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PROJECT No

22032



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REV

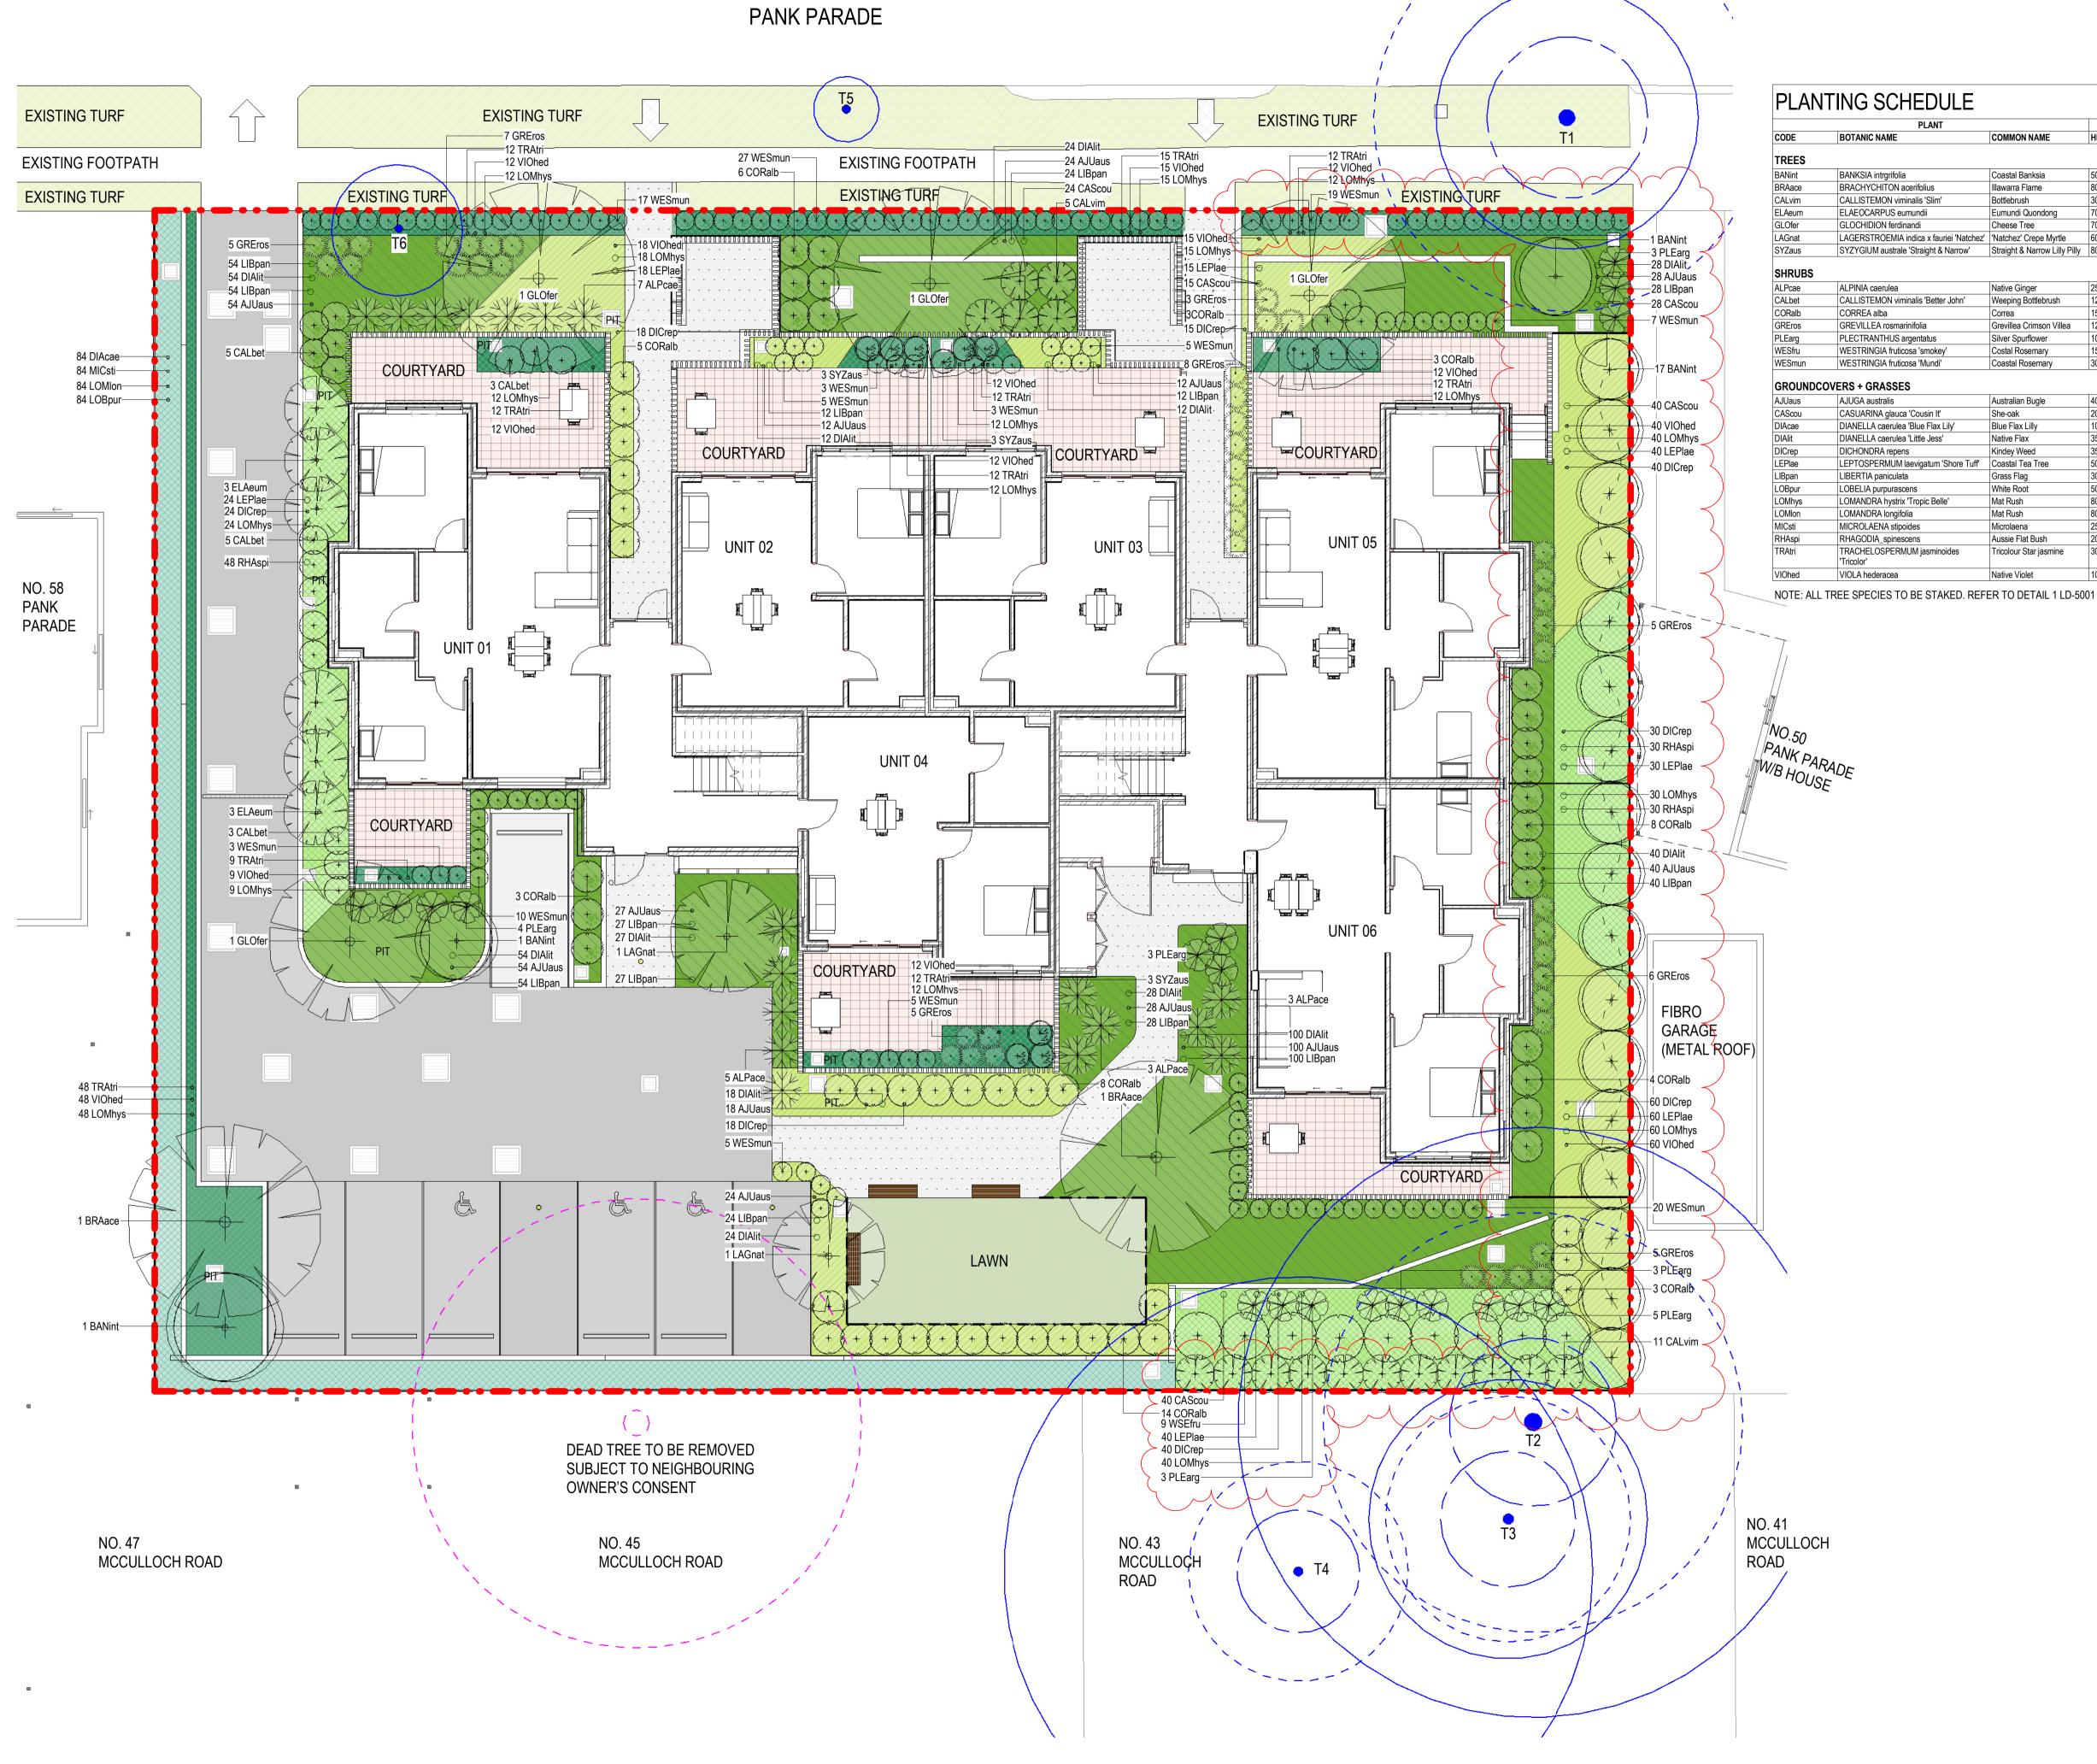Report any discrepancies to the architect before carrying out any work.

DESCRIPTION

AMENDMENTS

A 90% TENDER DOCUMENTATION LZ TW 08.09.2023 B 90% TENDER DOCUMENTATION LZ TW 03.11.2023

C 90% TENDER DOCUMENTATION LZ TW 09.11.2023

D 90% TENDER DOCUMENTATION LZ TW 22.11.2023

AUTH CHK DATE

			DIMENSIONS		
	COMMON NAME	HEIGHT (mm)	SPREAD(mm)	POT SIZE	No.
	Coastal Banksia	5000	2000	45Ltr	20
	Illawarra Flame	8000	7000	600Ltr	20
	Bottlebrush	3000	1200	45Ltr	16
	Eumundi Quondong Cheese Tree	7000	2000 4000	200Ltr 200Ltr	6 > 4
z'	'Natchez' Crepe Myrtle	6000	4000	200Ltr	<u>> 4</u> 2
<u> </u>	Straight & Narrow Lilly Pilly	8000	800	45Ltr	2
	Straight & Nanow Lilly Filly	0000	000		9
				7	•
	Native Ginger	2500	2000	200mm	> 18
	Weeping Bottlebrush	1200	600	200mm	16
	Correa	1500	1200	200mm	58
	Grevillea Crimson Villea	1200	1000	200mm	. 44
	Silver Spurflower	1000	1200	200mm	20
	Costal Rosemary	1500	1500	200mm	> 9
	Coastal Rosemary	300	600	200mm	129
	•	•	•		
	Australian Bugle	400	1000	140mm	421
	She-oak	200	1000	140mm	147
	Blue Flax Lilly	1000	800	140mm	84
	Native Flax	350	350	140mm	421
	Kindey Weed	350	350	140mm	247
	Coastal Tea Tree	500	1000	200mm	<u> </u>
	Grass Flag	300	300	140mm	484
	White Root	500	400	140mm	84
	Mat Rush	800	800	140mm	383
	Mat Rush	800	600	140mm	84
	Microlaena	250	200	140mm	> 84
	Aussie Flat Bush	200	1000	140mm	108
	Tricolour Star jasmine	300	600	140mm	156
	Native Violet	100	400	140mm	289
	INALIVE VIOLEL	100	400	140000	209



PROPOSED DEVELOPMENT AT 56 PANK PARADE, BLACKTOWN

GENERAL

- G1 These drawings shall be read in conjunction with all architectural and other consultants drawings and specifications and with such other written instructions and sketches as may be issued during the course of the Contract. Any discrepancies shall be referred to the Superintendent before proceeding with any related works. Construction from these drawings, and their associated consultant's drawings is not to commence until approved by the Local Authorities.
- G2 All materials and workmanship shall be in accordance with the relevant and current Standards Australia codes and with the By-Laws and Ordinances of the relevant building authorities except where varied by the project specification.
- G3 All set out dimensions shall be obtained from Architect's and Engineer's details. All discrepancies shall be referred to the Architect and Engineer for decision before proceeding with related work.
- G4 During construction the structure shall be maintained in a stable condition and no part shall be overstressed. Temporary bracing shall be provided by the builder/subcontractor to keep the works and excavations stable at all times.
- G5 Unless noted otherwise levels are in metres and dimensions are in millimetres.
- G6 The alignment and level of all services shown are approximate only. The contractor shall confirm the position and level of all services prior to commencement of construction. Any damage to services shall be rectified at the contractors expense
- Any substitution of materials shall be approved by the Engineer and included in any tender. G7
- G8 All services, or conduits for servicing shall be installed prior to commencement of pavement construction.
- G9 Subsoil drainage, comprising 100 agriculture pipe in geo-stocking to be placed as shown and as may be directed by the superintendent. Subsoil drainage shall be constructed in accordance with the relevant local authority construction specification.
- G10 The structural components detailed on these drawings have been designed in accordance with the relevant Standards Australia codes and Local Government Ordinances for the following loadings. Refer to the Architectural drawings for proposed floor usage. Refer to drawings for live loads and superimposed dead loads.

DRAINAGE NOTES

- D1 All drainage levels to be confirmed on site, prior to any construction commencing.
- D2 All pipes within the property to be a minimum of 100 dia upvc @ 1% minimum grade, uno.
- D3 All pits within the property are to be fitted with "weldlok" or approved equivalent grates: - Light duty for landscaped areas - Heavy duty where subjected to vehicular traffic
- D4 All pits within the property to be constructed as one of the following: Precast stormwater pits Cast insitu mass concret
- 3) Cement rendered 230mm brickwork subject to the relevant local authority construction specification. Ensure all grates to pits are set below finished surface level within the property. Top of pit RL's are D5
- approximate only and may be varied subject to approval of the engineer. All invert levels are to be achieved. Any pipes beneath relevant local authority road to be rubber ring jointed RCP, uno. D6
- D7 All pits in roadways are to be fitted with heavy duty grates with locking bolts and continuous hinge.
- D8 Provide step irons to stormwater pits greater than 1200 in depth.
- D9 Trench back fill in roadways shall comprise sharp, clean granular back fill in accordance with the relevant local authority specification to non-trafficable areas to be compacted by rodding and tamping using a flat plate vibrator
- **D10** Where a high early discharge (hed) pit is provided all pipes are to be connected to the hed pit, uno.
- D11 Down pipes shall be a minimum of dn100 sw grade upvc or 100 x100 colorbond/zincalume steel, uno.
- D12 Colorbond or zincalume steel box gutters shall be a minimum of 450 wide x 150 deep.
- D13 Eaves gutters shall be a minimum of 125 wide x 100 deep (or of equivalent area) colorbond or zincalume steel, und
- D14 Subsoil drainage shall be provided to all retaining walls & embankments, with the lines feeding into the stormwater drainage system, uno.

E1 These notes are to be read in conjunction with erosion and sediment control details in this drawing set.

EROSION AND SEDIMENT CONTROL NOTES

- E2 The contractor shall implement all soil erosion and sediment control measures as necessary and to the satisfaction of the relevant local authority prior to the commencement of and during construction. No disturbance to the site shall be permitted other than in the immediate area of the works and no material shall be removed from the site without the relevant local authority approval. All erosion and sediment control devices to be installed and maintained in accordance with standards outlined in nsw department of housing's "managing urban stormwater - soils and constructions".
- Place straw bales length wise in a row as parallel as possible to the site contours, uno. Bale ends to be E3 tightly butted. Bales are to be placed so that straws are parallel to the row. Bales are to be placed 1.5m to 2m downslope from the toe of the disturbed batter, uno.
- E4 Council approved filter fabric to be entrenched 150mm deep upslope towards disturbed surface. Fabric to be a minimum SF2000 or better. Fix fabric to posts with wire ties or as recomended with manufacturer's specifications. Fabric joints to have a minimum of 150mm overlap. Wire to be strung between posts with filter fabric overlap to prevent sagging.
- E5 Stabalised entry/exit points to remain intact until finished driveway is complete. Construction of entry/exit points to be maintained and repaired as required so that it's function is not compromised. Construction of entry/exit point to be in accordance with the detail contained within this drawing set.
- All drainage pipe inlets to be capped until: E6 - downpipes connected
- pits constructed and protected with silt barrier E6 Provide and maintain silt traps around all surface inlet pits until catchment is revegetated or paved.
- E7 The contractor shall regularly maintain all erosion and sediment control devices and remove accumulated silt from such devices such that more than 60% of their capacity is lost. All the silt is to be placed outside the limit of works. The period for maintaining these devices shall be at least until all disturbed areas are revegetated and further as may be directed by the superintendent or council.
- E8 The contractor shall implement dust control by regularly wetting down (but not saturating) disturbed area.
- E9 Topsoil shall be stripped and stockpiled outside hazard areas such as drainage lines. This topsoil shall be respread later on areas to be revegetated and stabilised only, (i.e. all footpaths, batters, site regarding areas, basins and catchdrains). Topsoil shall not be respread on any other areas unless specifically instructed by the superintendent. If they are to remain for longer than one month stockpiles shall be protected from erosion by covering them with a mulch and hydroseeding and, if necessary, by locating banks or drains downstream of a stockpile to retard silt laden runoff.
- E10 Lay 300 wide minimum turf strip on 100 topsoil behind all kerb and gutter with 1000 long returns every 6000 and around structures immediately after backfilling as per the relevant local authority specification.
- **E11** The contractor shall grass seed all disturbed areas with an approved mix as soon as practicable after completion of earthworks and regrading.
- E12 Revegetate all trenches immediately upon completion of backfilling.
- E13 When any devices are to be handed over to council they shall be in clean and stable condition.


STANDARD LINE TYPES AND SYMBOLS

	PROPOSED KERB & GUTTER
	EXISTING KERB & GUTTER
	PROPOSED BELOW GROUND PIPELINE
	PROPOSED SUSPENDED PIPELINE
	EXISTING PIPELINE
22 22 22	SUBSOIL DRAINAGE LINE
	PROPOSED KERB INLET PIT
	EXISTING KERB INLET PIT
	PROPOSED JUNCTION OR INLET PIT
	EXISTING JUNCTION OR INLET PIT
	DESIGN CENTRELINE
	EXISTING EDGE OF BITUMEN
TTT	TELECOMUNICATION CONDUIT
G G	GAS MAIN
vvv	WATER MAIN
sss	SEWER MAIN
vvv	UNDERGROUND ELECTRICITY CABLES
	PERMANENT MARK & S.S.M.
Δ Δ	BENCH MARK, SURVEY STATION

RECOMMENDED MAINTENANCE SCHEDULE

DISCHARGE CONTROL PIT (DCP)	FREQUENCY	RESPONSIBIL
Inspect flap valve and remove any blockage.	Six monthly	Owner
Inspect screen and clean.	Six monthly	Owner
Inspect & remove any blockage of orifice.	Six monthly	Owner
Inspect dcp sump & remove any sediment-sludge.	Six monthly	Owner
Inspect grate for damage or blockage.	Six monthly	Owner
Inspect return pipe from storage and return any blockage.	Six monthly	Owner
Inspect outlet pipe and remove any blockage.	Six monthly	Maintenance Contractor
Check fixing of step irons is secure.	Six monthly	Maintenance Contractor
Inspect overflow weir & remove any blockage.	Six monthly	Maintenance Contractor
Empty basket at overflow weir (if present).	Six monthly	Maintenance Contractor
Check attachment of orifice plate to wall of pit (gaps less than 5 mm).	Annually	Maintenance Contractor
Check attachment of screen to wall of pit.	Annually	Maintenance Contractor
Check screen for corrosion.	Annually	Maintenance Contractor
Check attachment of flap valve to wall of .	Annually	Maintenance Contractor
Check flap valve seals against wall of pit.	Annually	Maintenance Contractor
Check any hinges of flap valve move freely.	Annually	Maintenance Contractor
Inspect dcp walls (internal and external, if appropriate) for cracks or spalling.	Annually	Maintenance Contractor
Check step irons for corrosion.	Annually	Maintenance Contractor
Check orifice diameter correct and retains sharp edge.	Five yearly	Maintenance Contractor
STORAGE		
Inspect & remove any blockage of orifice.	Six monthly	Owner
Check orifice diameter correct and retains sharp edge.	Six monthly	Owner
Inspect screen and clean.	Six monthly	Owner
Check attachment of orifice plate to wall of pit (gaps less than 5 mm).	Annually	Maintenance
Check attachment of screen to wall of pit.	Five yearly	Maintenance Contractor
Check attachment of screen to wall of pit.	Five yearly	Maintenance Contractor

STANDARD LINE TYPES AND SYMBOLS

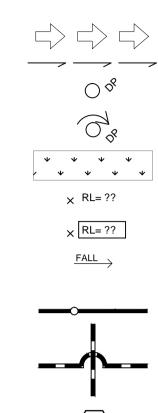

OVERLAND FLOW PATH GUTTER DRAINAGE DIRECTION DOWNPIPE DOWNPIPE WITH SIDE OVERFLOW PERVIOUS (GRASSED) AREAS EXISTING (PRE-DEVELOPMENT) RL

POST DEVELOPMENT RL

GRADED IMPERVIOUS AREA (ROOF, CONC SLABS ETC)

SEDIMENT FENCE

CROSSING PIPES

NODE POINT

LEGEND

AHD

AG

AR

BG

CL

CO

DP

DCP

DRP

EBG

EDP

EEG

EG

FRC

FW

GD

GSIP

HED

HP

10

O/F

OSD

PSD

RCP

RHS

RR.I

RRT

RWH

RWO

SLAP

SP

SPR

BWL

Australian height datum Ag-pipe (Sub soil drainage) Average recurrence interval ΤW Box Gutter Bottom water leve U/S Cover level VG Clean out inspection opening UNO Discharge control pit Down pipe Dropper pipe Existing box gutter Existing down pipe Existing eaves gutter Eaves gutter Fiber reinforced concrete Floor waste Grated drain Grated surface inlet pi High early discharge High point of gutter Invert level Inspection opening Overflow On-site detention Permissible site discharge Pipe 1 Reinforced concrete pipe Rectangular hollow section Reduced level Rubber ring joint Rainwater re-use tank Rain water head Rain water outlet Sealed lid access pit Spreader pipe Spreader

Stainless steel Box gutter sump Top of wall Top water level Underside of slab Vally gutter Unless noted otherwise

TWL

ILITY	PROCEDURE
	Remove grate. Ensure flap valve moves freely and remove any blockages or debris.
	Revove grate and screen if required and clean it.
	Remove grate & screen to inspect orifice. see plan for location of dcp.
	Remove grate and screen. Remove sediment/sludge build-up and check orifice and flap valve clear.
	Check both sides of grate for corrosion, (especially corners and welds) damage or blockage.
	Remove grate and screen. ventilate underground storage if present. open flap valve and remove any blockages in return line. Check for sludge/debris on upstream side of return line.
	Remove grate and screen. ventilate underground storage if present. Check orifice and remove any blockages in outlet pipe. Flush outlet pipe to confirm it drains freely. Check for sludge/debris on upstream side of return line.
	Remove grate and ensure fixings secure prior to placing weight on step iron.
	Remove grate and open cover to ventilate underground storage if present. ensure weir clear of blockages.
	Remove grate and ventilate underground storage chamber if present. Empty basket, check fixings secure and not corroded.
	Remove grate and screen. ensure plate mounted securely, tighten fixings if required. seal gaps as required.
	Remove grate and screen. ensure screen fixings secure. repair as required.
	Remove grate and examine screen for rust or corrosion, especially at corners or welds.
	Remove grate. Ensure fixings of valve are secure.
	Remove grate. fill pit with water and check that flap seals against side of pit with minimal leakage.
	Remove grate. Test valve hinge by moving flap to full extent.
	Remove grate to inspect internal walls. Repair as required. Clear vegetation from external walls if necessary and repair as required.
	Remove grate. Examine step irons and repair any corrosion or damage.
	Compare diameter to design (see work-as- executed) and ensure edge is not pitted or damaged.
	Remove grate and screen. remove sediment/sludge build-up.
	Remove blockages from grate and check if pit blocked.
	Remove debris and floatable material likely to be carried to grates.
	Remove grate to inspect internal walls. repair as required. clear vegetation from external walls if necessary and repair as required.
	Compare actual storage available with work-as executed plans. If volume loss is greater than 5%, arrange for reconstruction to replace the volume lost. Council to be notified of the proposal.
	Check along drainage lines and at pits for subsidence likely to indicate leakages.

NOTE: DO NOT SCALE OFF DRAWINGS. REFER TO ARCHITECTURAL PLANS. VERIFY DIMENSIONS ON SITE

P3	11.11.22	ISSUED FOR CO-ORDINATION	0.G.
P2	09.11.22	ISSUED FOR CO-ORDINATION	O.G.
P1	11.10.22	ISSUED FOR REVIEW	O.G.
REV	DATE	DESCRIPTION	BY

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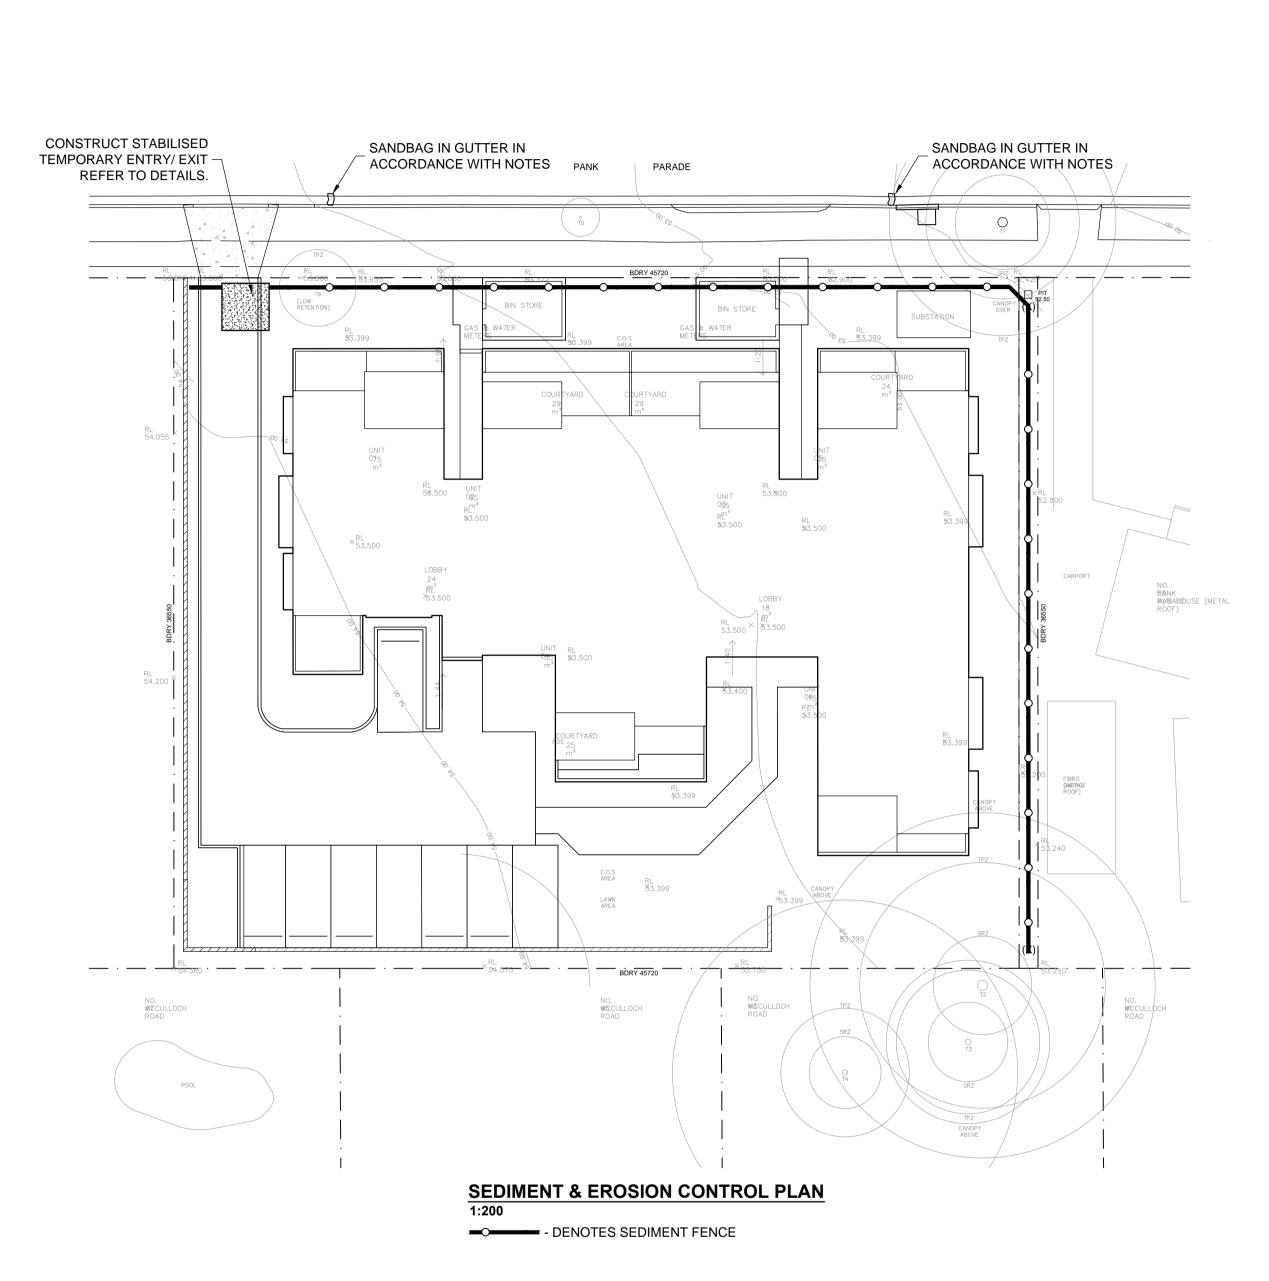
Postal Address

Web: www.engineeringstudio.com.au NORWEST NSW 2153 PROPOSED DEVELOPMENT

AT 56 PANK PARADE, BLACKTOWN FOR MODE DESIGN

GENERAL NOTES

JOB NUMBER:	DWG NUMBER:	ORIGINAL	SIZE:
220109	C10.01	A ^	1
DESIGNED BY: O.G.	DATE: SEPTEMBER 2022		
DRAWN BY: O.G.	SCALE: SCALE		





THE CONTRACTOR SHALL ENSURE THAT NO SPOIL OR FILL E ADJACENT AREAS FOR THE DURATION OF WORKS.

THE CONTRACTOR SHALL ENSURE THAT KERB INLETS AND D STORMWATER SHALL BE PROTECTED AT ALL TIMES DURING KERB INLET SEDIMENT TRAPS SHALL BE INSTALLED ALONG T VICINITY ALONG THE STREET FRONTAGE.


SEDIMENT FENCING SHALL BE SECURED BY POST (WHERE M ARE USED PLASTIC SAFETY CAPS SHALL BE USED) AT 2000 II GEOTEXTILE FABRIC EMBEDDED 200 IN SOIL.

ALL TOPSOIL STRIPPED FORM THE SITE AND STOCKPILED DO WITH DRAINAGE LINES AND STORMWATER INLETS AND WILL COVERED WITH AN IMPERVIOUS MEMBRANE MATERIAL AND SEDIMENT FENCING.

SEDIMENT TRAP

1000 x 1000 WIDE 500 DEEP PIT, LOCATED AT THE LOWEST PO SEDIMENT.

WASHOUT AREA TO BE 1800 x 1800 ALLOCATED FOR THE WA EQUIPMENT.

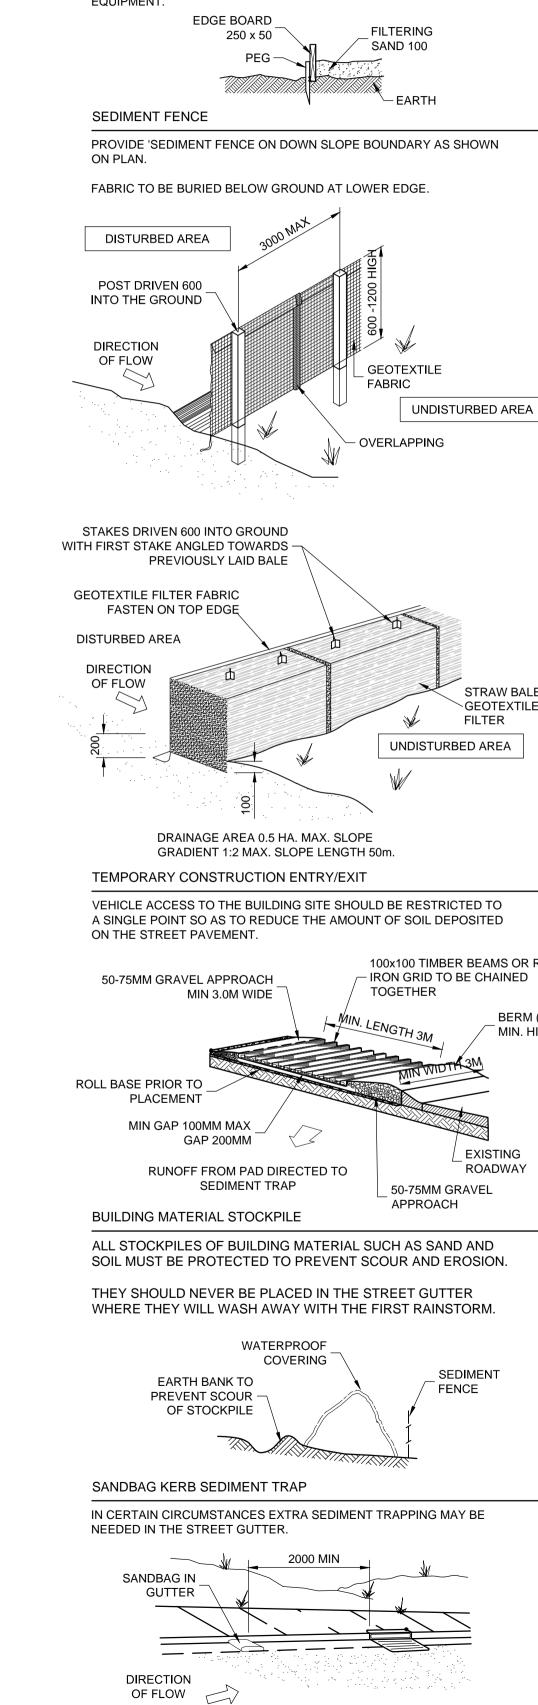

DETERMINED by the NSW Land and Housing Corporation on:

			<u> </u>
	GENERAL NOTES	20 December 2023	
ENCROACHES UPON DRAINS RECEIVING G DEVELOPMENT. THE IMMEDIATE	CONSULTANTS' DRAWINGS WRITTEN INSTRUCTIONS A	BE READ IN CONJUNCTION WITH AND SPECIFICATIONS AND WITH S MAY BE ISSUED DURING THE C ANCY SHALL BE REFERRED TO TH ORK.	HOTHER SUCH COURSE OF THE
METAL STAR PICKETS		ILLIMETRES & ALL LEVELS ARE IN SE). NO DIMENSION SHALL BE OB	
INTERVALS WITH		OUT DIMENSIONS SHOWN ON TH R TO THE COMMENCEMENT OF	
DOES NOT INTERFERE LL BE SUITABLY D SCREENED BY	DURING EXCAVATION WOR STABLE AND NO PART SHA	K THE STRUCTURE SHALL BE MALL BE MALL BE OVERSTRESSED.	AINTAINED IN A
	ALL WORK IS TO BE UNDER ON THE DRAWINGS & THE S	RTAKEN IN ACCORDANCE WITH T SPECIFICATION.	HE DETAILS SHOWN
POINT TO THE TRAP	AND SUCH THEIR ACCURAC RESPONSIBILITY OF THE C	E SHOWN HAVE BEEN PLOTTED CY CAN NOT BE GUARANTEED. IT ONTRACTOR TO ESTABLISH THE TO THE COMMENCEMENT OF W	LEVEL OF ALL
		NDER VEHICULAR PAVEMENTS S REQUIREMENTS OF THE LOCAL	
	ALL TRENCH BACK FILL MA AS THE ADJACENT MATERI	TERIAL SHALL BE COMPACTED 1 AL.	O THE SAME DENSITY
AS SHOWN	BE RESTORED TO ORIGINA	MWATER INSTALLATION, ALL DIS L CONDITION, INCLUDING KERBS L AND GRASSED AREAS AND RO WISE.	S, FOOTPATHS,
	CONTRACTOR TO OBTAIN A	ALL AUTHORITY APPROVALS UNL	LESS DIRECTED
	STORMWATER DRAINAG	E_	
		AGE DESIGN HAS BEEN CARRIED	OUT IN ACCORDANCE
		MWATER DRAINAGE" & AS/NZS 3 - ACCEPTABLE SOLUTIONS".	3500.3.2-1998
	ANY VARIATIONS TO THE N ENGINEER IMMEDIATELY.	OMINATED LEVELS SHALL BE RE	FERRED TO
E	ANY VARIATIONS TO SPEC THE ENGINEER FOR APPRO	FIED PRODUCTS OR DETAILS SH DVAL.	IALL BE REFERRED TO
ISTURBED AREA	DOWN PIPES SHALL BE A M COLORBOND OR ZINCALUM	IINIMUM OF DN100 SW GRADE uF 1E STEEL, UNO.	2VC OR 100 X 100
3	BOX COLORBOND OR ZINC WIDE X 150 DEEP.	ALUME STEEL. GUTTERS SHALL	BE A MINIMUM OF 450
		A MINIMUM OF 125 WIDE X 100 E BOND OR ZINCALUME STEEL.	DEEP (OR OF
		BE PROVIDED TO ALL RETAINING LINES FEEDING INTO THE STORI	
	SEDIMENT AND EROSIO	N CONTROL NOTES	
	TIMES DURING THE COURS	CONTROL SHALL BE EFFECTIVEL E OF CONSTRUCTION AND SHAL STABILISED OR LANDSCAPED TO FACTION	L NOT BE REMOVED
STRAW BALE AND GEOTEXTILE SEDIMENT FILTER	PROPERTY CONSISTING OF MINIMUM THICKNESS OF 15	CCESS WAY WILL BE PROVIDED A 50-75 AGGREGATE OR SIMILAR 50 LAID OVER NEEDLE-PUNCHED TO COMMENCEMENT OF WO	MATERIAL AT A GEOTEXTILE FABRIC
JRBED AREA	SOIL CONSERVATION NO	DTE	
		T OF CONSTRUCTION PROVIDE ' SHOUT AREA TO ENSURE THE CA TED FROM THE SITE.	
	MAINTAIN THE ABOVE DUR 'SEDIMENT TRAP AFTER EA	ING THE COURSE OF CONSTRUC ACH STORM.	CTION, AND CLEAR THE

100x100 TIMBER BEAMS OR RAILWAY

BERM (0.3M MIN. HIGH)

EXISTING

ROADWAY

SEDIMENT

	NOTE: DO NOT SCALE OFF DRAWINGS. REFER TO ARCHITECTURAL PLANS. VERIFY DIMENSIONS ON SITE				
P3	11.11.22	ISSUED FOR CO-ORDINATION	O.G.		
P2	09.11.22	ISSUED FOR CO-ORDINATION	O.G.		
P1	11.10.22	ISSUED FOR REVIEW	0.G.		
RE	/ DATE	DESCRIPTION	BY		
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0.G.

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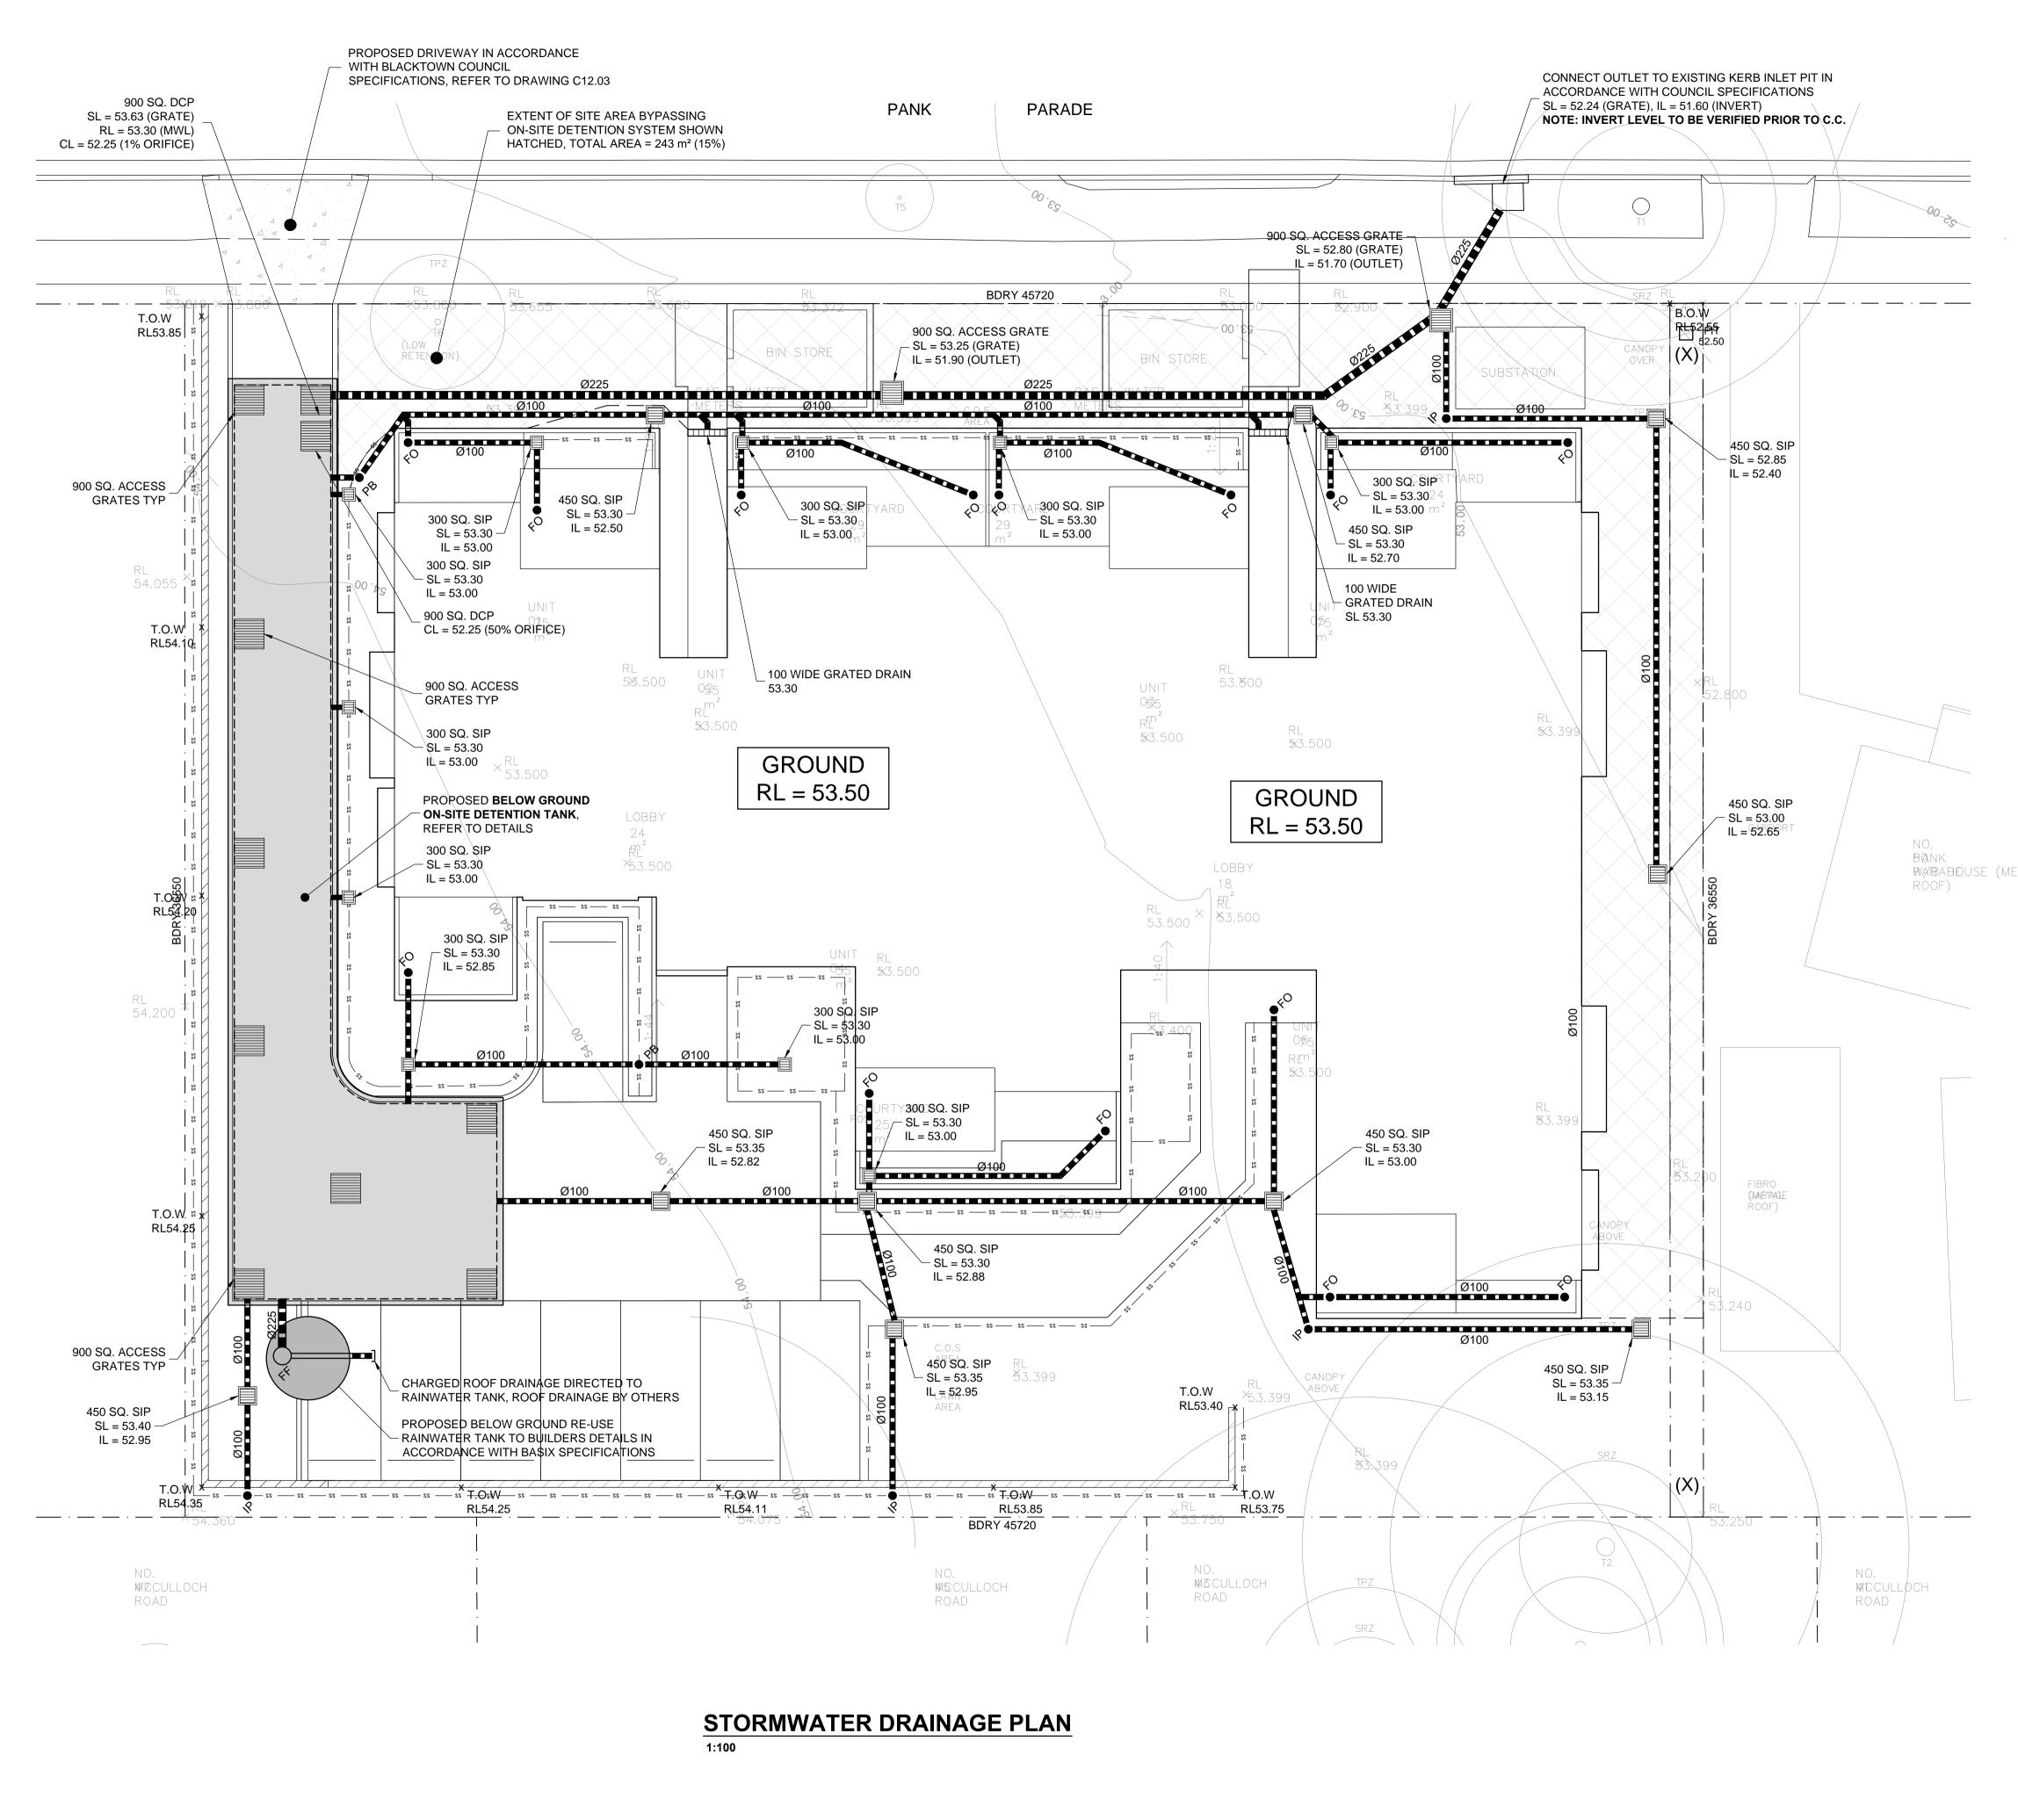
 Web: www.engineeringstudio.com.au
 NORWEST NSW 2153

Civil & Structural Postal Address

PROPOSED DEVELOPMENT AT 56 PANK PARADE, BLACKTOWN FOR MODE DESIGN

SEDIMENT & EROSION CONTROL PLAN					
JOB NUMBER:	DWG NUMBER:	ORIGINA	L SIZE:		
220109	C11.01	A	.1		
DESIGNED BY:	DATE:				
O.G.	SEPTEMBER 2022				
DRAWN BY:	SCALE:				

1:200 U.N.O.



20 December 2023 STORMWATER DESIGN SUMMA	RY
COUNCIL: BLACKTOWN CITY COUNCIL 100 YEAR, 5 MIN STORM 20 YEAR, 5 MIN STORM	= 225 mm/h = 172 mm/h
TOTAL SITE AREA	$= 1670 \text{ m}^2$
PROPOSED BUILDING FOOTPRINT IMPERVIOUS PATHS & DRIVEWAYS TOTAL IMPERVIOUS SITE AREA IMPERVIOUS SITE PERCENTAGE	= 700 m^2 = 412 m^2 = 1112 m^2 = 67%
100% PROPOSED ROOF AREA DIRECTED TO RAINWATER RE-USE TANK TO BUILDERS DE ACCORDANCE WITH BASIX SPECIFICATION OVERFLOW DIRECTED TO PROPOSED BELO DETENTION (OSD) TANK. OSD DISCHARGE I STREET KERB INLET PIT VIA GRAVITY IN AC COUNCIL STORMWATER SPECIFICATIONS.	ETAILS IN S. HIGH LEVEL DW GROUND ON-SITE DIRECTED TO
WATER SENSITIVE URBAN DESIGN SUMMAI SITE LOCATED WITHIN SECTION 7.11 CONT No.19 - BLACKTOWN GROWTH PRECINCT AI WATER CONSERVATION & QUALITY CONTR SUBJECT TO VOLUNTARY CONTRIBUTION II WITH BLACKTOWN COUNCIL CODE.	RIBUTIONS PLAN REA THEREFORE NO OLS REQUIRED
ON-SITE DETENTION DESIGN S	UMMARY
CATCHMENT: HAWKESBURY RIVER SUBCA ON-SITE DETENTION REQUIRED FOR PROP DEVELOPMENTS WITH A SITE AREA GREAT ACCORDANCE WITH 'BLACKTOWN COUNCI GUIDE FOR DEVELOPMENT SECTION A.2' .	OSED COMMERCIAL ER THAN 500m ² IN
PERCENTAGE OF TOTAL SITE DRAINED DETERMINED SITE STORAGE REQUIREMEN DETERMINED SITE STORAGE REQUIREMEN	
DETERMINED PERMISSIBLE SITE DISCHARC MAXIMUM HEAD TO ORIFICE CENTRE LINE DETERMINED 100 YEAR ORIFICE DIAMETER DETERMINED 1.5 YEAR ORIFICE DIAMETER	= 1.10 m = 105 mm
STORAGE PROVIDED IN OSD TANK	= 76.3 m ³
STORMWATER DRAINAGE NOT	ES
 ALL DRAINAGE LINES SHALL BE uPVC (CL STORMWATER DRAINAGE PIPE, U.N.O. ALL DRAINAGE LINES SHALL BE LAID @ 1⁴ FIRST FLUSH RAINWATER DEVICES TO BE DRAINAGE LINES TO BUILDER'S DETAIL, T 	% FALL MIN, U.N.O. E FITTED TO
LEGEND	
downpipe by others	
INSPECTION POINT	
ぐC FIRST FLUSH RAINWATER I BUILDERS DETAIL	DEVICE TO
X 100.00 PROPOSED FINISHED SURF	ACE LEVEL
(c) CHARGED PIPE	
PROPOSED BELOW GROUN	D PIPELINE
PROPOSED BELOW GROUN SS - SUBSOIL DRAINAGE LINE	ID PIPELINE

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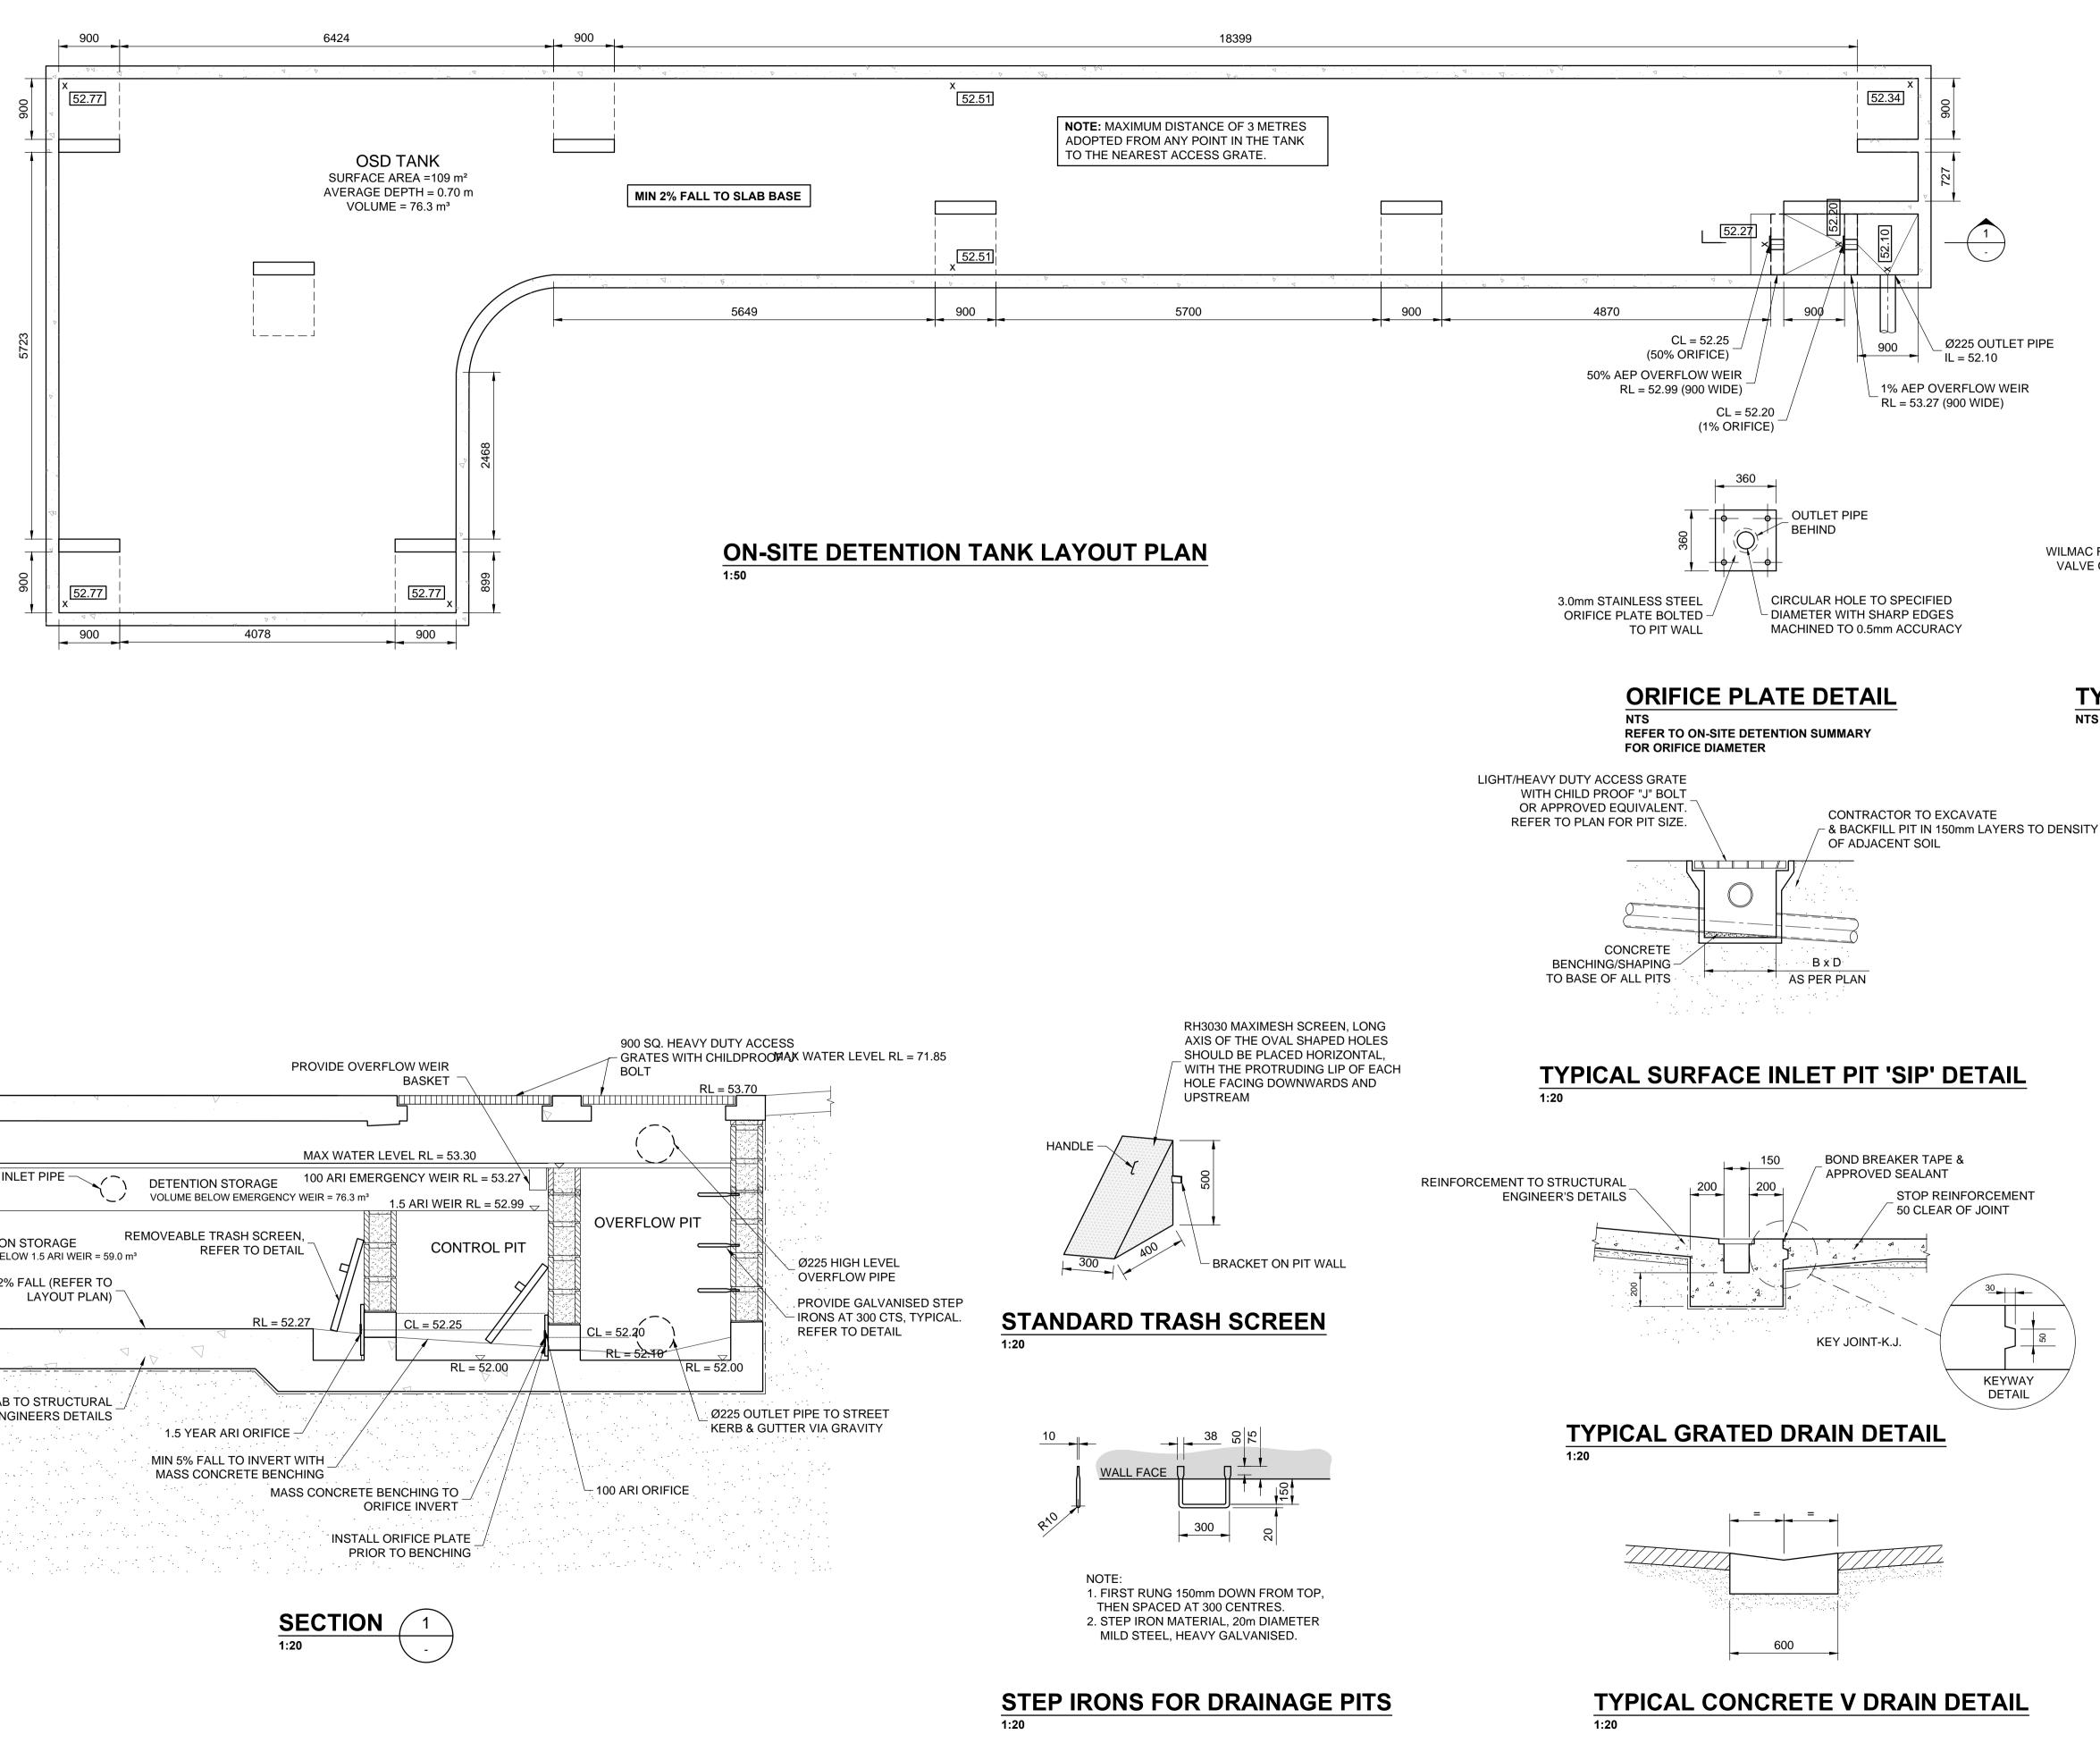
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 Email: info@engineeringstudio.com.au
 PO Box 7191


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PROPOSED DEVELOPMENT AT 56 PANK PARADE, BLACKTOWN FOR MODE DESIGN

STORMWATER DRAINAGE PLAN

JOB NUMBER:	DWG NUMBER:	ORIGINAL SIZE:	
220109	C12.01	A1	
DESIGNED BY: O.G.	DATE: SEPTEMBER 2022		
DRAWN BY: O.G.	SCALE: 1:200 U.N.O.		





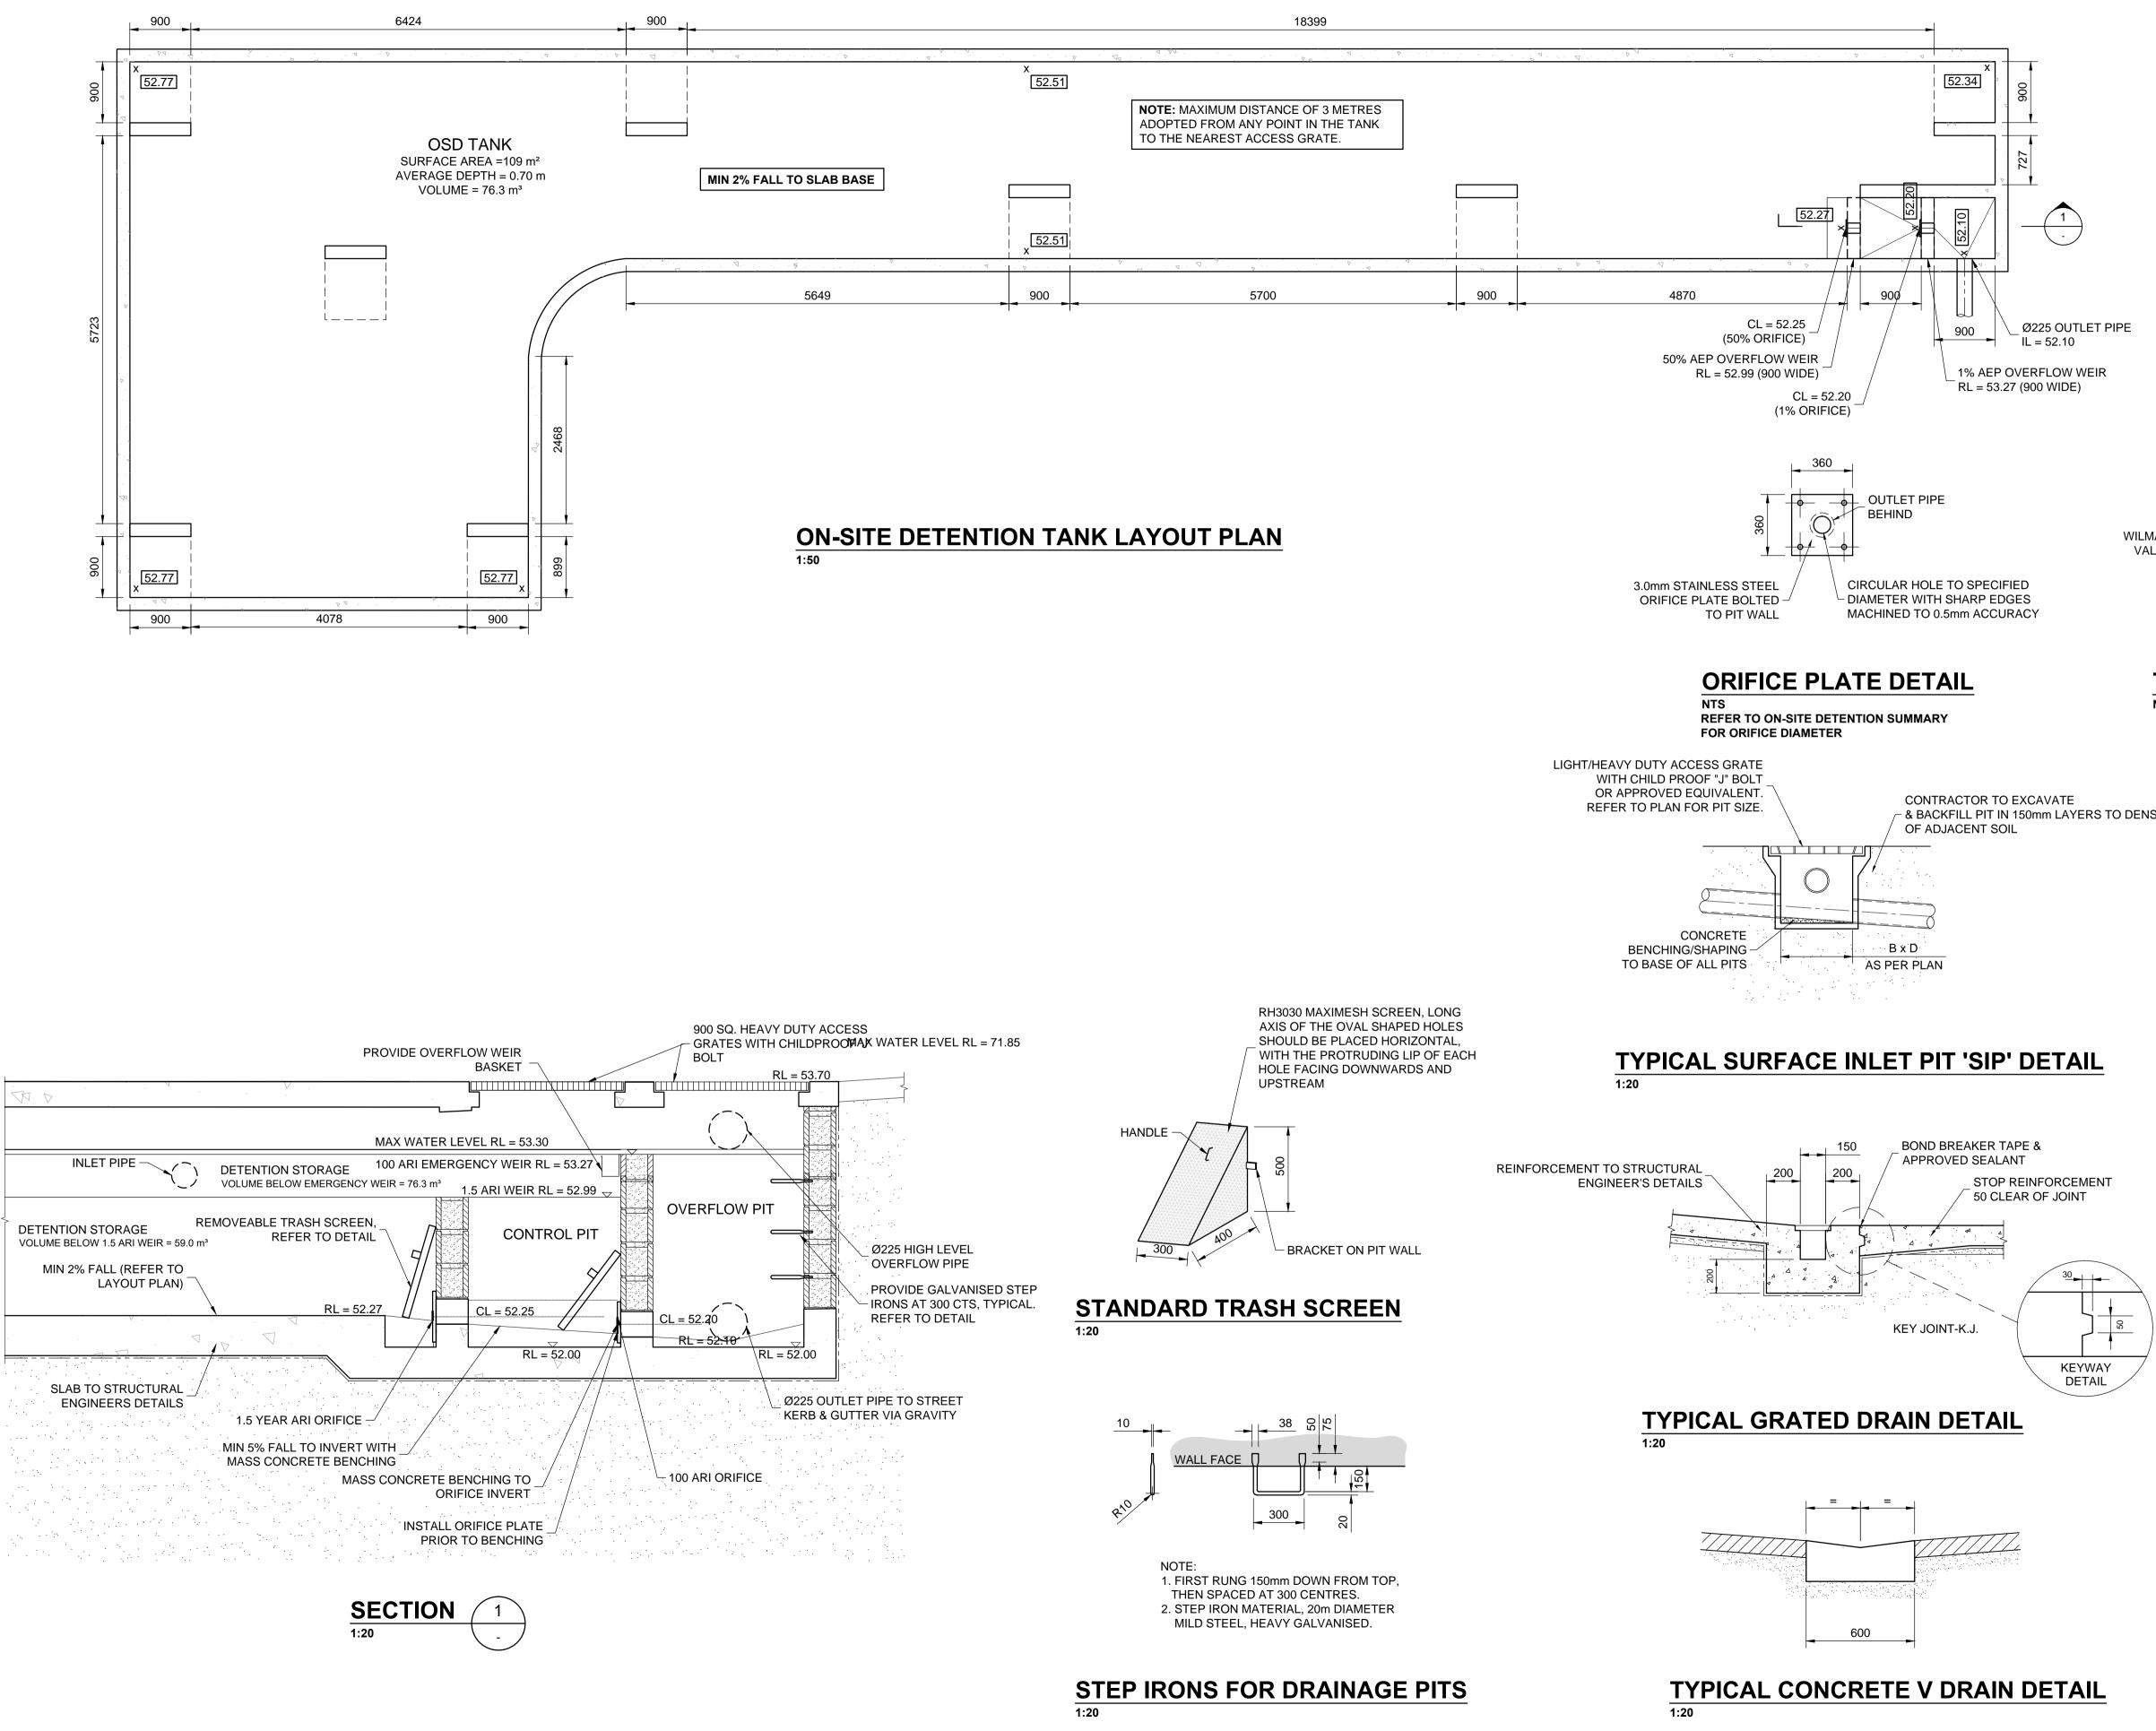


WILMAC FLEXIBLE FLAP VALVE OR APPROVED EQUIVALENT

TYPICAL FLAP VALVE DETAIL NTS

A	ARCHITECTURAL PLANS. VERIFY DIMENSIONS ON SITE					ГЕ
P3	11.11.22	ISSUED	FOR CO-ORDIN	ATION		0.G.
P2	09.11.22	ISSUED FOR CO-ORDINATION			O.G.	
P1	11.10.22	ISSUED	ISSUED FOR REVIEW			O.G.
REV	DATE	DESCRIP	DESCRIPTION			BY
All Th the rep	COPYRIGHT All rights reserved. These drawings, plans and specifications and the copyright are the property of Engineering Studio and must not be used, reproduced or copied wholly or in part without the written permission of Engineering Studio. Engineering Studio Civit & Structurol Postal Address Po Box 7191 NGWEST NSW 2153					
	PROPOSED DEVELOPMENT AT 56 PANK PARADE, BLACKTOWN FOR MODE DESIGN					
	STOP	RMWA	TER DE		SHEET	
JOB I	NUMBER:		DWG NUMBER:		ORIGINAL S	IZE:
	22040	0	C12	20	Λ.1	

NOTE: DO NOT SCALE OFF DRAWINGS. REFER TO

OOD NOMBER.	BWG NOMBER		
220109	C12.02	A1	
DESIGNED BY: O.G.	DATE: SEPTEMBER 2022		
DRAWN BY: O.G.	SCALE: 1:20 U.N.O.		

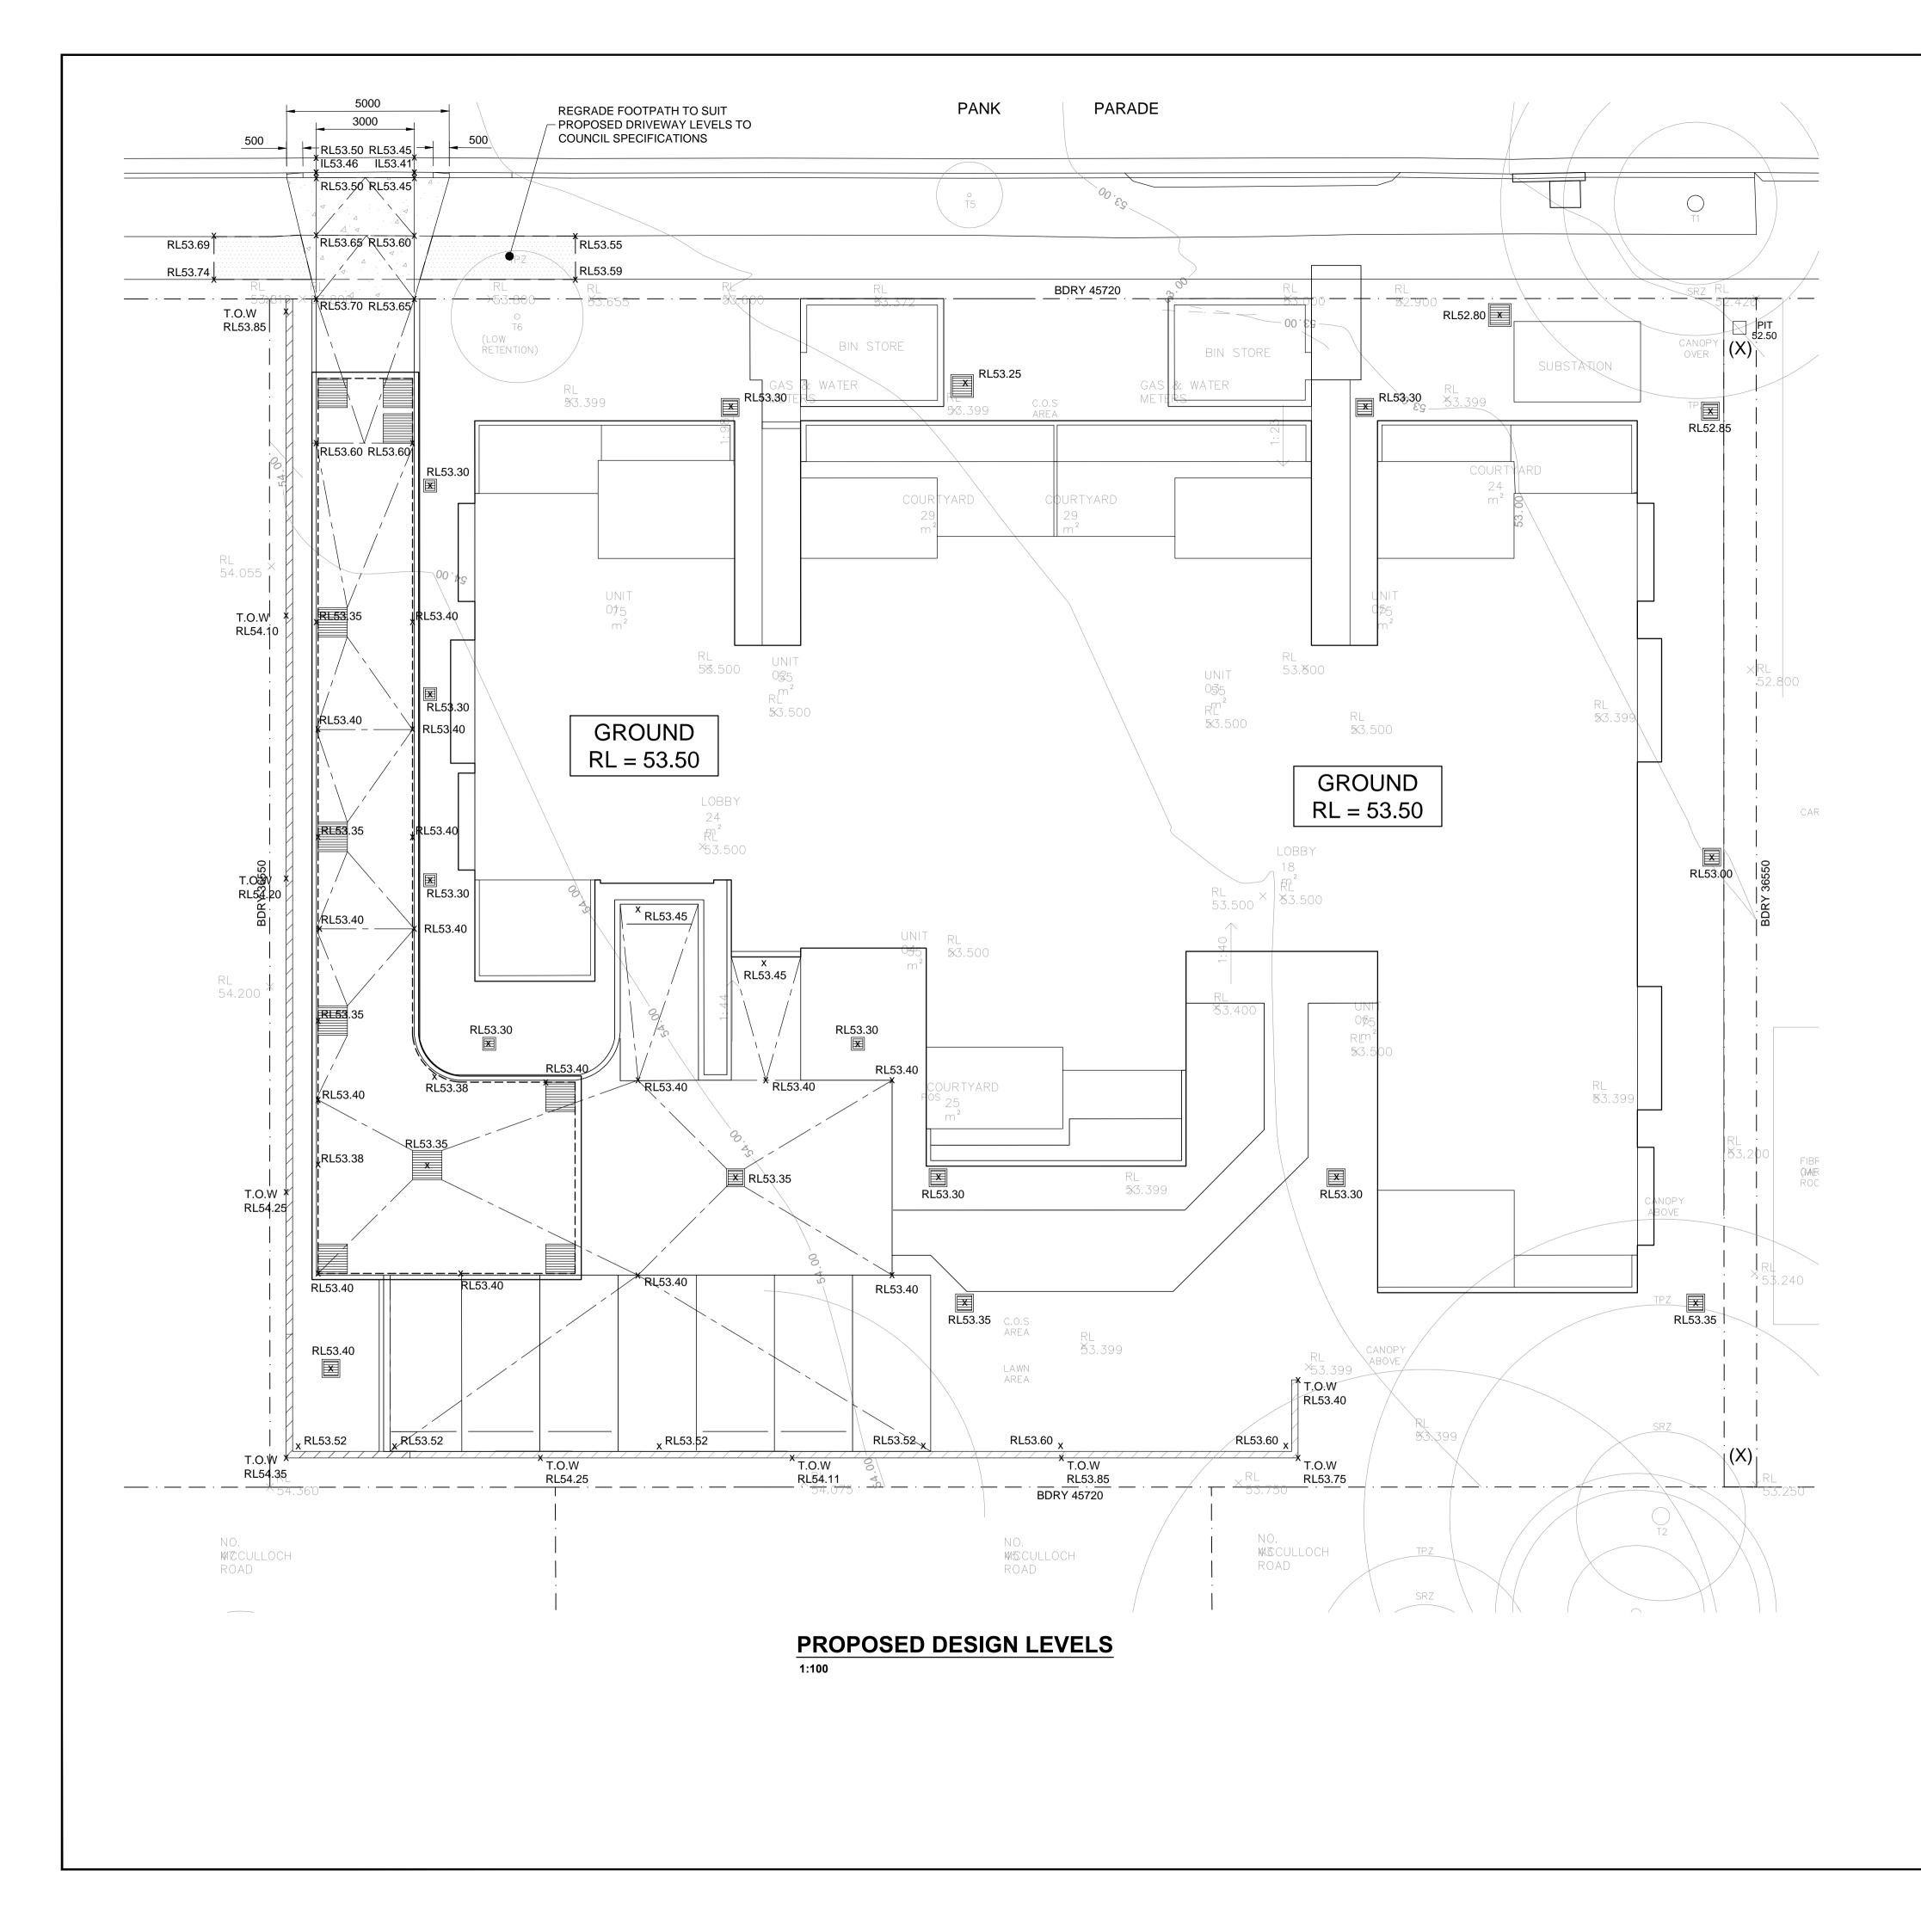

Elech

NOTE: DO NOT SCALE OFF DRAWINGS. REFER TO ARCHITECTURAL PLANS. VERIFY DIMENSIONS ON SITE

P3	11.11.22	ISSUED FOR CO-ORDINATION	O.G.
P2	09.11.22	ISSUED FOR CO-ORDINATION	O.G.
P1	11.10.22	ISSUED FOR REVIEW	O.G.
REV	DATE	DESCRIPTION	BY

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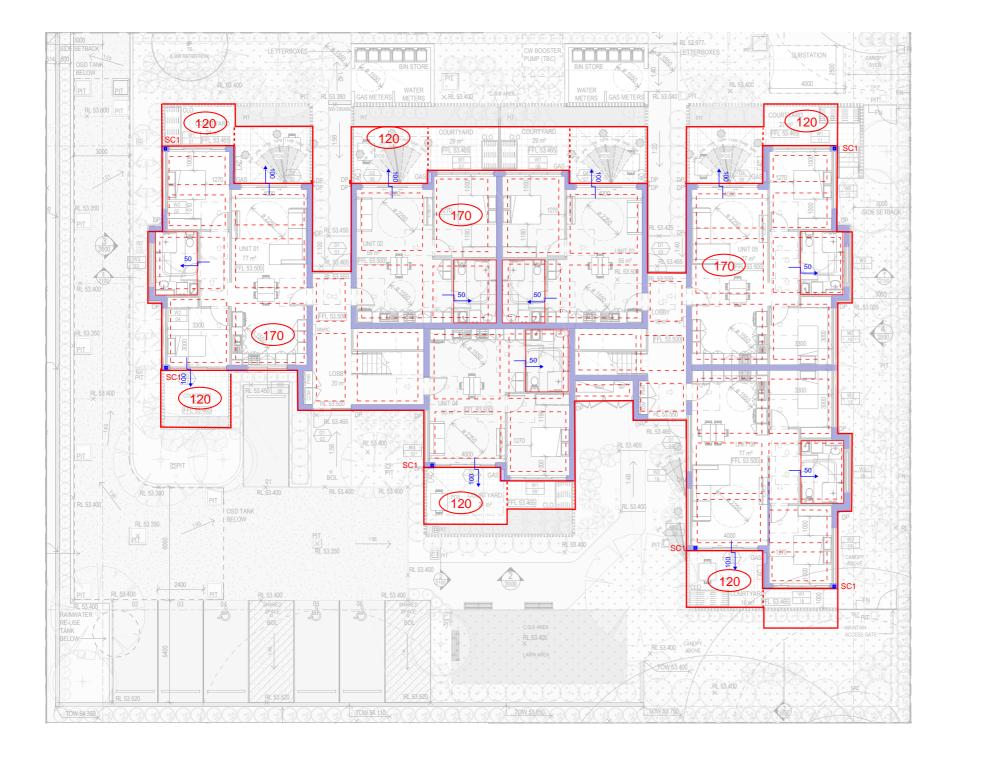
 Email: info@engineeringstudio.com.au
 PO Box 7191

 Web: www.engineeringstudio.com.au
 NORWEST NSW 2153

PROPOSED DEVELOPMENT AT 56 PANK PARADE, BLACKTOWN FOR MODE DESIGN

PROPOSED DESIGN LEVELS

JOB NUMBER:	DWG NUMBER:	ORIGINAL SIZE:	
220109	C12.03	A1	
DESIGNED BY:	DATE:		
O.G.	SEPTEMBER 2022		
DRAWN BY:	SCALE:		
O.G.	1:200 U.N.O.		



NOTES * 450 DIA PILES - 4m CTS MAX ROCK R10 TIES - 500 CTS * 170 THICK SLAB (U.N.O) 25 MPa

- AREAS

MEMBERS	SCHED
SC1 -	89 x 8 COLU
	LOAD OVEF
	LOAD UNDE



20 December 2023

+ UNDER ALL LOAD BEARING ELEMENTS TO BE SOCKETED 1.5m INTO WEATHERED

* 450W x 450D STRIP FOOTINGS 4N16 T&B

N12-200 CTS T&B + 2 N12 TOP OVER PILES

* ALL LOAD-BEARING WALLS TO BE EITHER SINGLE SKIN MASONRY OR DOUBLE BRICK WITH A 50mm CAVITY (U.N.O)

* 50mm SETDOWN FOR ALL INTERNAL WET


DULE

89 SHS STEEL UMN

D BEARING MEMBER R

D BEARING MEMBER ER

	PART	5
DRAWING TITLE :	DATE :	SCALE :
GROUND FLOOR -	18.11.22	1:200
PLAN		
	PROJECT No :	ISSUE :
PROJECT :	AC3403	3
BLACKTOWN LAHC,		
52-56 PANK PARADE,	DRAWING No :	
BLACKTOWN NSW 2148	SK01	

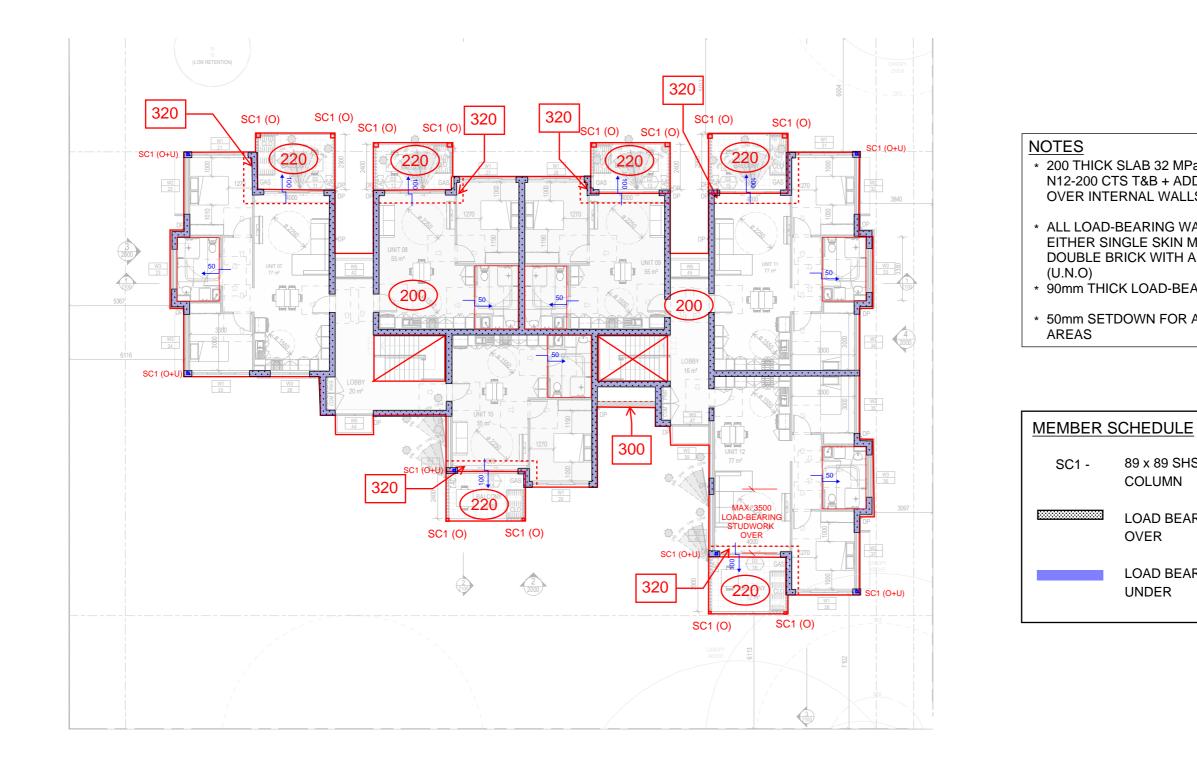





* 200 THICK SLAB 32 MPa N12-200 CTS T&B + ADDITIONAL TOP OVER INTERNAL WALLS

* ALL LOAD-BEARING WALLS TO BE EITHER SINGLE SKIN MASONRY OR DOUBLE BRICK WITH A 50mm CAVITY

* 90mm THICK LOAD-BEARING STUDWORK


* 50mm SETDOWN FOR ALL INTERNAL WET

89 x 89 SHS STEEL COLUMN


LOAD BEARING MEMBER OVER

LOAD BEARING MEMBER UNDER

		PART	5
DRAWING TITLE : FIRST FLOC PLAN	PR -	DATE : 18.10.22	scale : 1:200
PROJECT : BLACKTOW		PROJECT No : AC3403	ISSUE : 3
52-56 PANK BLACKTOW	PARADE,		02

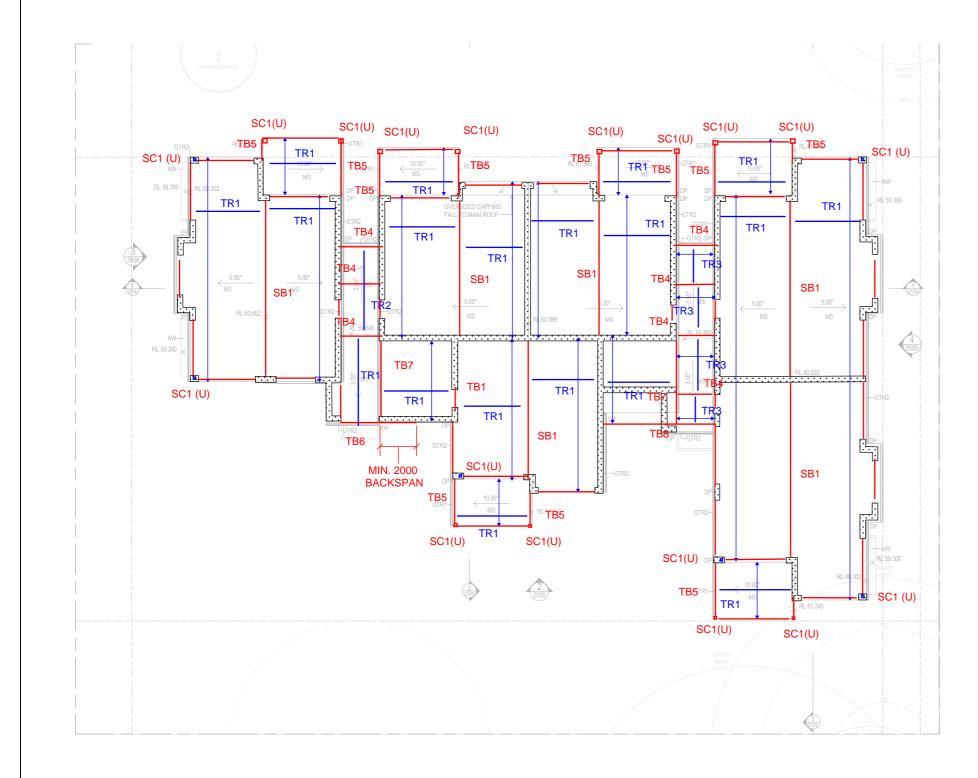

MEMBER SCHED
TR1 - HYSPAN 20
TR2 - HYSPAN 15
TR3 - HYSPAN 15
TB1 - HYSPAN 30
TB4 - HYSPAN 20
TB5 - HYSPAN 20
TB6 - HYSPAN 24
TB7 - HYSPAN 20
TB8 - HYSPAN 20
SB1 - 250UB31.4

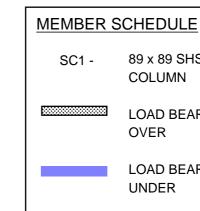





HEDULE

AN 200 X 45 @ 900 CENTRES AN 150 x 45 @ 900 CENTRES AN 150 x 45 @ 900 CENTRES AN 300 x 63 AN 200 x 63 AN 200 x 45 AN 240 x 63 AN 200 x 63 AN 200 x 45

89 x 89 SHS STEEL

LOAD BEARING MEMBER

LOAD BEARING MEMBER

	DRAWING TITLE :	DATE :	SCALE :		
	ROOF -	18.11.22	1:200		
	PLAN				
		PROJECT No :	ISSUE :		
		AC3403	3		
	PROJECT :	100100	Ũ		
-	BLACKTOWN LAHC, 52-56 PANK PARADE, BLACKTOWN NSW 2148	DRAWING No .			
		SK03			

